

UNCOMMON ETHEL

ENTITLEMENT SET // 5.31.2023

GENERAL CONTRACTOR // UNCOMMON DEVELOPERS		ELECTRICAL ENGINEER // SABAG ELECTRIC CORPORATION		GENERAL	LANDSCAPE	ARCHITECTURAL CONT.	MECHANICAL	ELECTRICAL
9220 WINNETKA AVE	LEON BENRIMON	8786 YOLANDA AVE.	JONATHAN SABAG					LLLOTTIOAL
LOS ANGELES, CA 91311	310.980.7206 // LEON@UNCOMMONDEVELOPERS.COM	NORTHRIDGE, CA 91324	818.974.4450 // JONATHAN@SABAGELECTRIC.COM	G000 COVER SHEET G001 PROJECT INFORMATION	L0.01 GENERAL INFORMATION L1.11 HARDSCAPE PLAN - LEVEL 1 WEST	A600 ENLARGED UNIT PLANS A601 ENLARGED UNIT PLANS	M001 GENERAL NOTES SCHEDULE AND LEGENDS	
GENERAL CONTRACTOR // UNCOMMON DEVELOPERS		PLUMBING ENGINEER // LEWIS ROSS ASSOCIATES, INC		G001 PROJECT INFORMATION G002 SITE PHOTOS & EXISTING CONDITIONS	L1.11 HARDSCAPE PLAN - LEVEL 1 WEST L1.12 HARDSCAPE PLAN - LEVEL 1 EAST	A602 ENLARGED UNIT PLANS	M002 GENERAL NOTES SCHEDULE AND LEGENDS M003 GENERAL NOTES SCHEDULE AND LEGENDS	
9220 WINNETKA AVE	DAVID MAS	25061 AVE STANFORD SUITE	TRAVIS PREMO	G003 RENDERINGS G009 GROSS AREA CALCULATIONS	L1.13 HARDSCAPE PLAN - LEVEL 3 L1.21 HARDSCAPE DETAILS	A603 ENLARGED UNIT PLANS A650 ENLARGED PLANS AND ELEVATIONS	M004 EQUIPMENT SCHEDULE M110 1ST FLOOR PLAN	
LOS ANGELES, CA 91311	323.833.7733 // DAVID@UNCOMMONDEVELOPERS.COM	120 VALENCIA, CA 91355	808.439.6870 // TRAVIS.PREMO@LEWISROSS.COM	G009 GROSS AREA CALCULATIONS G010 ZONING CODE AREA DIAGRAMS	L1.21 HARDSCAPE DETAILS L1.31 MEP COORDINATION PLAN - LEVEL 1 WEST	A650 ENLARGED PLANS AND ELEVATIONS A661 ENLARGED COURTYARD PLAN	M110 1ST FLOOR PLAN M120 2ND FLOOR PLAN	
GENERAL CONTRACTO	DR // UNCOMMON DEVELOPERS			G012 OPEN SPACE CALCULATIONS	L1.32 MEP COORDINATION PLAN - LEVEL 1 EAST	A710 1ST FLOOR RCP	M130 3RD FLOOR PLAN	
9220 WINNETKA AVE	CARLOS SANCHEZ			G013 OCCUPANCY LOAD DIAGRAMS G016 CODE COMPLIANCE DIAGRAMS	L1.33 MEP COORDINATION PLAN - LEVEL 3 L2.11 IRRIGATION PLAN - LEVEL 1 WEST	A720 2ND FLOOR RCP A730 3RD FLOOR RCP	M140 4TH FLOOR PLAN M150 5TH FLOOR PLAN	
LOS ANGELES, CA 91311	626.665.2836 // CARLOS@UNCOMMONDEVELOPERS.COM			G030 BUILDING RECORDS	L2.12 IRRIGATION PLAN - LEVEL 1 EAST	A740 4TH FLOOR RCP	M160 6TH FLOOR PLAN	
OWNER // 5511 ETHEL L LOS ANGELES, CA ARCHITECT // JEFF ZBI	KOWSKI ARCHITECTURE			G031 BUILDING RECORDS G040 TYPICAL DAS DETAILS (CBC) G041 TYPICAL DAS DETAILS (CBC) G042 TYPICAL DAS DETAILS (CBC) G060 SOIL APPROVAL G080 SURVEY	L2.13 IRRIGATION PLAN - LEVEL 3 L3.11 PLANTING PLAN - LEVEL 1 WEST L3.12 PLANTING PLAN - LEVEL 1 EAST L3.13 PLANTING PLAN - LEVEL 3 L3.21 PLANTING DETAILS	A750 5TH FLOOR RCP A760 6TH FLOOR RCP A770 7TH FLOOR RCP A980 BIKE RACK DETAILS A990 BIKE RACK DETAILS	M170 7TH FLOOR PLAN M180 ROOF PLAN	
4043 IRVING PL, SUITE B	JEFF ZBIKOWSKI, AIA			G081 SURVEY				
CULVER CITY, CA 90232	310.853.5004 // JEFF@JZARCH.LA				ARCHITECTURAL	STRUCTURAL	PLUMBING	
CIVIL ENGINEER // DK E					A000 SITE PLAN	31113313111112	1 Edividing	
6420 WILSHIRE BLVD SUITE	DAN KRIEF				A110 1ST FLOOR PLAN			
1000 LOS ANGELES, CA 90048	310.926.0248 // DKRIEF@DKENGINEERCORP.COM				A120 2ND FLOOR PLAN A130 3RD FLOOR PLAN			
LANDSCAPE ARCHITECT // TGP, Inc.					A130 3RD FLOOR PLAN A140 4TH FLOOR PLAN			
PO BOX 704	, NANDA RAGHUNATHAN			CIVIL	A150 5TH FLOOR PLAN A160 6TH FLOOR PLAN			
MONTROSE, CA 91021	818.797.5914 // NANDAR@TGPINC.NET			C0.01 TITLE SHEET	A160 6TH FLOOR PLAN A170 7TH FLOOR PLAN			
STRUCTURAL ENGINEER // DCI ENGINEERS				C0.02 SOILS APPROVAL LETTER SHEET	A180 ROOF PLAN A200 ELEVATIONS			
523 W 6TH ST SUITE	NOLAN G. LENAHAN			C1.00 SURVEY (FOR REFERENCE ONLY) C1.01 SURVEY (FOR REFERENCE ONLY)	A200 ELEVATIONS A201 ELEVATIONS			
616 LOS ANGELES, CA 90014	916.337.1449 // NLENAHAN@DCI-ENGINEERS.COM			C1.10 EROSION CONTROL AND DEMOLITION PLAN	A202 COURTYARD ELEVATIONS			
MECHANICAL ENGINEER // PRECISE AIR SYSTEMS				C1.20 ROUGH GRADING PLAN C1.21 ROUGH GRADING SECTIONS C4.22 CAPADING HORIZONTAL CONTROL AND BAYING PLAN	A300 BUILDING SECTIONS A301 BUILDING SECTIONS A500 FM ADDED BLAND AND DESCRIPTIONS FLEWATOR #4			

GRADING, HORIZONTAL CONTROL, AND PAVING PLAN

A500 ENLARGED PLANS AND SECTIONS ELEVATOR #1

A501 ENLARGED PLANS AND SECTIONS ELEVATOR #2

A511 ENLARGED PLANS AND SECTION STAIR #2
A512 ENLARGED PLANS AND SECTION STAIR #3 & STAIR #4

A510 ENLARGED PLANS AND SECTION STAIR #1

UTILITY AND LID PLAN - LEVEL 1

UTILITY AND LID PLAN - LEVEL 3


C2.00 DETAILS
C2.01 DETAILS

5467 SAN FERNANDO RD ARIS SHAHMIRZAIAN

WEST LOS ANGELES, CA 90039 818.140.1737 // ARIS@PRECISEAIR.COM



JEFF ZBIKOWSKI ARCHITECTURE 4043 IRVING PL, SUITE B CULVER CITY, CA 90232 WWW.JZARCH.LA // 310.853.5004 INFO@JZARCH.LA

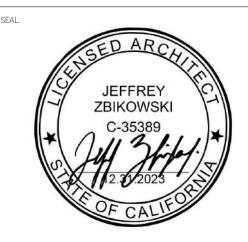

REVISIONS:

©2022, JEFF ZBIKOWSKI ARCHITECTURE

ALL DESIGNS, IDEAS, ARRANGEMENTS AND PLANS INDICATED BY
THESE DRAWINGS ARE THE PROPERTY AND COPYRIGHT OF THE
ARCHITECT AND SHALL NEITHER BE USED ON ANY OTHER WORK NOR
BE DISCLOSED TO ANY OTHER PERSON FOR ANY USE WHATSOEVER
WITHOUT WRITTEN PERMISSION OF THE ARCHITECT.

UNCOMMON DEVELOPERS
9220 N WINNETKA AVE
CHATSWORTH, CA 91311

UNCOMMON

NOT FOR CONSTRUCTION

PROJECT ADDRESS:

5511 N ETHEL AVE
SHERMAN OAKS, CA

HERMAN OAKS
B NUMBER:

DATE: 5.31.2023

SHEET TITLE:


COVER SHEET

SHEET NUMBER:

) ;	AT DIAMETER	_	FLR FMC FOC	FACE	OR MATERIAL CHANGE OF CONCRETE	P PIP PLAM	PROPERTY LINE PROTECT IN PLACE PLASTIC LAMINATE
B /C CT	ANCHOR BOL AIR CONDITIC ACOUSTIC CE	NING	FOF FOM FOS	FACE	OF FINISH OF MASONRY OF STUD	PT PTD	PAINT PAINTED
DA		WITH DISABILITIES ACT	FR FS	FIRE	RESISTIVE H SURFACE	QTY	QUANTITY
DJ FF	ADJACENT ABOVE FINISH ALTERNATE	H FLOOR	GA	GAGE	E 'ANIZED	R RCP RD	RADIUS or RISER REFLECTED CEILING PLAN
LT LUM PPROX	ALUMINUM APPROXIMAT	ELY	GALV GB GC	GRAE		REF REQ'D	ROOF DRAIN REFRIGERATOR REQUIRED
RCH	ARCHITECT		GYP BD	GYPS	SUM BOARD	REV RM	REVISION or REVISED ROOM
D F LK	BOARD BRACE FRAM BLOCK	E	HB HC HCW	HOLL	E BIBB .OW CORE .OW CORE WOOD	ROW RRM	RIGHT OF WAY RESTROOM
M TWN	BEAM BETWEEN		HDR HM	HEAD HOLL	DER OW METAL	SC SCW	SOLID CORE SOLID CORE WOOD
B	CABINET CENTER LINE		HR HT	HAND HEIGI		SF SHT	SQUARE FEET SHEET
L LG	CENTER LINE CLOSET CEILING		INS INT	INSUL INTER	LATION RIOR	SHTG SIM SL	SHEATHING SIMILAR SLOPE
LR MU		IASONRY UNIT	JST	JOIST		ST STL STL	STAINLESS STEEL STEEL
OL ONC ONT	COLUMN CONCRETE CONTINUOUS	3	LAM LAV	LAMII LAVA	NATE TORY	STRUCT	STRUCTURAL TREAD
ONTR PT	CONTRACTOR CARPET		LIN	LINOL	LEUM	TBD TH	TO BE DETERMINED THRESHOLD
RS T	COURSES CERAMIC TILE	≣	MAX MECH MFR		MUM HANICAL JFACTURER	THK TJ TO	THICK TRUSS JOIST TOP OF
D) AS	DEMOLISH DISABLED AC	CESS	MIN MISC	MINIM		TOC TOP	TOP OF CONCRETE TOP OF PLATE
BL IA	DOUBLE DIAMETER		MO MTD	MASC MOUN	ONRY OPENING NTED	TOS TOSHTG	TOP OF SLAB TOP OF SHEATHING
IM N S	DIMENSION DOWN DOWNSPOUT		MTL N	META NOTE		TOW TYP	TOP OF WALL TYPICAL
WG	DRAWING		(N) NIC	NEW NOT I	IN CONTRACT	UNO	UNLESS NOTED OTHERWISE
E) LECT LEV	EXISTING ELECTRICAL ELEVATOR		NTS OC		TO SCALE ENTER	VCT VERT VIF	VINYL COMPOSITION TILE VERTICAL VERIFY IN FIELD
OS Q	EDGE OF SLA EQUAL	νB	OFCI	OWNI CONT	ER FURNISHED- FRACTOR INSTALLED	W/	WITH
XT E	EXTERIOR FIRE EXTINGL	IISHER	OFOI OFVI	OWN	ER FURNISHED- ER INSTALLED ER FURNISHED-	WC WD WH	WATER CLOSET WOOD WATER HEATER
E F IN J	FINISH FLOOF FINISH		OFVI OH OPNG	VEND	OOR INSTALLED RHEAD	WH WP WPT	WATERPROOF WORK POINT
A A A A A A A A A A A A A A A A A A A	В	WALL SECTION INTERIOR ELEVATION EXTERIOR ELEVATION	/- N	₩P T N13	WORK POINT NOTE ACCESSIBLE PATH OF TRAVEL	(AD) (AD) FM	AREA DRAIN FLOOR DRAIN FLOOR MATERIAL TRANSITION
_					FENCE	Н●Н	SECURITY OPENING
	-	ELEVATION MARK	(<u>)</u>	$\stackrel{\bigstar}{\rightarrow}$	EXIT SIGN		SECONITY OF ENING
	LADBS AP	PROVAL STAMP					


OPEN SPACE CALCULATIONS	ZONING CODE AREA CALCULATIONS	PROJECT INFORMATION		
TOTAL OPEN SPACE REQUIREMENTS PER LAMC 12.21.G: <3 HABITABLE ROOMS = 100 SF / UNIT (STUDIOS & 1BR UNITS)	RESIDENTIAL FLOOR AREA RATIO DEFINITION PER LAMC 12.03: A RATIO ESTABLISHING THE RELATIONSHIP BETWEEN A PROPERTY AND THE AMOUNT OF DEVELOPMENT PERMITTED FOR THAT PROPERTY, EXPRESSED AS A PERCENTAGE OR A RATIO OF THE LOT SIZE	PROJECT NAME: ADDRESS:	UNCOMMON ETHEL 5501-5511 ETHEL AVE	
=3 HABITABLE ROOMS = 125 SF / UNIT (2BR UNITS) >3 HABITABLE ROOMS = 175 SF / UNIT (3BR UNITS)	BASE ALLOWABLE RFAR PER LAMC 12.09.1: 45% OF LOT SIZE PER LA R1-1 ZONE TOTAL ALLOWABLE FLOOR AREA: LOT AREA X ALLOWABLE FAR = ALLOWABLE FLOOR AREA	ENTITLEMENTS:	SHERMAN OAKS, CA 91401 NOT YET FILED	
OPEN SPACE REQUIRED	41,810 SF X 45% = 18,814.50 SF ALLOWED	OWNER:	5511 ETHEL LLC	
UNIT TYPE HABITABLE ROOMS # OF UNITS REQ'D OPEN SPACE 1 BR 2 172 17,200 SF	AREA SCHEDULE (FLOOR AREA) LEVEL FAR AREA	PROJECT DESCRIPTION:	NEW CONSTRUCTION, 7-STORY, 200-UNIT, 146,896 SF, 100% AFFORDABLE HOUSING DEVELOPMENT SEEKING ON-MENU & OFF- MENU INCENTIVES PER LAMC 12.22.A25 & AB1763	
2 BR 3 22 2,750 SF 3 BR 4 1 175 SF STUDIO 1 5 500 SF	1ST FL FFE MISC 3,363 SF 2ND FL FFE MISC 2,669 SF	PROJECT FUNDING:	100% PRIVATELY FUNDED THIS IS NOT A PUBLIC HOUSING FACILITY OWNED AND/OR OPERATED BY, FOR OR ON BEHALF OF A PUBLIC ENTITY AND NO	17 /
GRAND TOTAL 200 20,625 SF	4TH FL FFE MISC 1,971 SF 5TH FL FFE MISC 1,971 SF		TAX CREDIT SHALL BE RECEIVED FROM STATE OR FEDERAL GOVERNMENTS. NOT A TCAC FACILITY AND NOT A SOCIAL SERVICE CENTER.	
PROJECT SEEKS A 58.2% REDUCTION OF OPEN SPACE PER LAMC 12.22.A.25 REQUIRED OPEN SPACE = 20,625 SF X 50% = 10,312.50 SF	6TH FL FFE MISC 1,971 SF 7TH FL FFE MISC 1,971 SF MISC 15,895 SF	CONSTRUCTION TYPE:	TYPE-IA (1ST-2ND FLOORS) TYPE-IIIA (3RD-7TH FLOORS)	ARCHITECTUR
50% MIN COMMON OPEN SPACE = 10,312.50 SF X 50% = 5,156.25 SF 25% OF COMMON OPEN SPACE SHALL BE 10,312.50 SF X 25% = 2,578.125 SF	1ST FL FFE PARKING 22,760 SF 2ND FL FFE PARKING 22,763 SF PARKING 45,523 SF	OCCUPANCY TYPE:	2-HR EXT WALLS PER LABC TABLE 601 R-2, A-3 S-2, B	ARCHITECT JEFF ZBIKOWSKI ARCHITECTURE
PLANTED TREE REQUIREMENTS:	3RD FL FFE RESIDENTIAL 16,804 SF 4TH FL FFE RESIDENTIAL 17,168 SF 5TH FL FFE RESIDENTIAL 17,168 SF	SPRINKLERED:	NFPA-13 PER LAFC 903.2 MANUAL ALARM	4043 IRVING PL, SUITE B CULVER CITY, CA 90232 WWW.JZARCH.LA // 310.853.5004
(1) 24" BOX TREE FOR EVERY 4 UNITS 200 UNITS = 50 TREES (1) 24" BOX TREE FOR EVERY 500 SF 1,830 SF = 4 TREES	6TH FL FFE RESIDENTIAL 17,168 SF 7TH FL FFE RESIDENTIAL 17,168 SF RESIDENTIAL 85,478 SF	FIRE ALARM: ACCESSIBILITY:	CBC 11A	INFO@JZARCH.LA
FRONT YARD LANDSCAPING: NOTES:	GRAND TOTAL 146,896 SF	ZONING INFORMA	TION	SEAL ARCHIA
1. A KITCHEN IS NOT CONSIDERED A HABITABLE ROOM FOR THE PURPOSES OF CALCULATING OPEN SPACE	TOTAL PROVIDED FLOOR AREA: 146,896 SF	ZONE: ZONING INFORMATION:	R1-1 ZI-2462 MODIFICATIONS TO SF ZONES AND SF ZONE HILLSIDE AREA	JEFFREY ZBIKOWSKI
2. PER LAMC 12.21.G.2(a)(1)(iii) COMMON OPEN SPACE MUST HAVE MINIMUM AREA OF 400 SF WITH NO HORIZONTAL DIMENSIONSLESS THAN 15' WHEN MEASURED PERPENDICULAR FROM ANY POINT ON EACH OF THE BOUNDARIES.	PROJECT SEEKS AN OFF-MENU REQUEST TO ALLOW 782% RFAR	ZONING INI ONIVIATION.	REGULATIONS ZI-2452 TRANSIT PRIORITY AREA IN THE CITY OF LOS ANGELES	C-35389
	RESIDENTIAL FLOOR AREA RATIO (RFAR) DEFINITION PER LAMC 12.03: THE AREA IN SQUARE FEET CONFINED WITHIN THE EXTERIOR WALLS OF A RESIDENTIAL OR NON-RESIDENTIAL BUILDING ON A LOT IN AN RA, RE, RS, OR R1 ZONE. ANY FLOOR OR PORTION OF A FLOOR	GENERAL PLAN LAND USE: ASSESSOR PARCEL NUMBER:	LOW RESIDENTIAL (RD5 DENSITY ALLOWED BY GENERAL PLAN) 2345-005-016	2.15/2023 A
OPEN SPACE PROVIDED NAME TYPE LEVEL AREA COMMON OPEN OPEN OPEN.	WITH A CEILING HEIGHT GREATER THAN 14 FEET SHALL COUNT AS TWICE THE SQUARE FOOTAGE OF THAT AREA. THE AREA OF STAIRWAYS AND ELEVATOR SHAFTS SHALL ONLY BE COUNTED ONCE REGARDLESS OF CEILING HEIGHT. AREA OF AN ATTIC OR PORTION OF AN ATTIC WITH A CEILING HEIGHT OF MORE THAN 7 FEET SHALL BE INCLUDED IN THE RESIDENTIAL FLOOR AREA CALCULATION.	TRACT: BLOCK:	TR 1000 NONE	REVISIONS:
COMMON OPEN SPACE 1ST FL FFE 7,160 SF COMMON OPEN SPACE 3RD FL FFE 4,770 SF COMMON OPEN SPACE 11,930 SF	AUTOMOBILE PARKING	LOT:	88, ARB 19	
GRAND TOTAL 11,930 SF	ZERO PARKING REQUIRED FOR 100% AFFORDABLE HOUSING DEVELOPMENT WITHIN 1/2 MILE OF MAJOR	FLOOD ZONE: METHANE ZONE:	OUTSIDE FLOOD ZONE NONE	
PLANTED OPEN SPACE = 3,460 SF	TRANSIT STOP PER AB1763.	SITE AREA: REQUIRED SETBACKS:	41,810 SF PER SURVEY FRONT: 20'-0"	
OCCUPANCY AREA CALCULATIONS	PARKING SCHEDULE (STALL SIZE) COMPACT RESIDENTIAL 48	-	SIDE: 10'-0" (5'-0" + 1' EVERY STORY ABOVE THE 2ND) REAR: 15'-0"	
	EV RESIDENTIAL 19 EV ACCESSIBLE RESIDENTIAL 2 1ST FL FFE 69	PROVIDED SETBACKS:	FRONT: 20'-0" SIDE: 8'-11" PER LAMC 12.22.A.25 20% REDUCTION REAR: 15'-0"	
	COMPACT RESIDENTIAL 47 EV RESIDENTIAL 22 2ND FL FFE 69	ALLOWABLE HEIGHT PER LAMC: PROVIDED HEIGHT PER LAMC:	28'-0" PER LAMC 12.21.1.A + 33' PER AB1763 = 61'-0" 80'-4", SEE ELEVATIONS & SURVEY FOR LOWEST ADJ. GRADE	
	Grand total 138	ALLOWABLE HEIGHT PER LABC:	85'-0" PER LABC TABLE 504.3	
		PROVIDED HEIGHT PER LABC: ALLOWABLE FLOOR AREA:	75'-10 1/2" 5 & 8/G016 FOR AVG. GRADE PLANE & ROOF EL. CALCS 25,399 SF (45% RFAR PER R1-1 & 35% BONUS PER LAMC 12.22.A.25)	
	OF WHICH 2% SHALL BE ACCESSIBLE OF WHICH AT LEAST 1 SHALL BE VAN ACCESSIBLE 1 VAN ACCESSIBLE STALL	PROVIDED FLOOR AREA: ALLOWARI E DENSITY PER GENERAL PLAN	146,896 SF = 343% RFAR LOW RESIDENTIAL GENERAL PLAN DESIGNATION PER VAN NUYS -	
	OF WHICH 30% SHALL BE EV CAPABLE OF WHICH AT LEAST 10% SHALL BE EV INSTALLED 43 EV CAPABLE STALLS 15 EV STALLS WITH CHARGERS	ALLOWADLE DENSITY ET GENETALT LAN	NORTH SHERMAN OAKS COMMUNITY PLAN = RD5 DENSITY = 1 UNIT PER 5,000 SF OF LOT AREA	
UNIT SCHEDULE & AFFORDABILITY	BICYCLE PARKING	ALLOWABLE DENSITY PER AB1763:	41,810 / 5,000 = 8.36 ROUND UP = 9 UNITS BASE DENSITY UNLIMITED	
UNIT SCHEDULE	BICYCLE PARKING REQUIRED PER LAMC 12.21.A.16: LONG TERM PARKING: UNITS 1-25: 1 STALL PER UNIT	PROVIDED DENSITY: REQUIRED PARKING:	200 UNITS, 160 HUD LOW INCOME, 39 HCD MODERATE INCOME NONE WHEN WITHIN 1/2 MILE OF MAJOR TRANSIT STOP, SEE G075	
NUMBER OF REQUIRED REQUIRED NAME BEDROOMS COUNT OPEN SPACE PARKING AREA Level	UNITS 26-100: 1 STALL PER 1.5 UNITS UNITS 101-200: 1 STALL PER 2 UNITS 125 STALLS REQUIRED		FOR TRANSIT VERIFICATION FORM	
1 BR 1 36 3,600 SF 0 14,293 SF 3RD FL FFE 1 BR 1 34 3,400 SF 0 13,446 SF 4TH FL FFE 1 BR 1 34 3,400 SF 0 13,434 SF 5TH FL FFE	SHORT TERM PERKING: UNITS 1-25: 1 STALL PER 10 UNITS UNITS 26-100: 1 STALL PER 15 UNITS	PROVIDED PARKING:	138 STALLS, SEE PARKING SECTION	
1 BR 1 34 3,400 SF 0 13,446 SF 6TH FL FFE 1 BR 1 34 3,400 SF 0 13,434 SF 7TH FL FFE 1 BR: 172 172 17,200 SF 0 68,053 SF	UNITS 101-200: 1 STALL PER 15 UNITS UNITS 101-200: 1 STALL PER 20 UNITS 13 STALLS REQUIRED			
2 BR 2 2 250 SF 0 1,161 SF 3RD FL FFE 2 BR 2 5 625 SF 0 2,991 SF 4TH FL FFE 2 BR 2 5 625 SF 0 2,982 SF 5TH FL FFE	BICYCLE PARKING PROVIDED:			
2 BR 2 5 625 SF 0 2,982 SF 6TH FL FFE 2 BR 2 5 625 SF 0 2,982 SF 7TH FL FFE	LONG TERM PARKING: 85 STALLS PROJECT SEEKS WAIVER SHORT TERM PARKING: 12 STALLS	INCENTIVES REQU	IESTED	
2 BR: 22 22 2,750 SF 0 13,099 SF 3 BR 2 1 175 SF 0 785 SF 3RD FL FFE 3 BR: 1 1 175 SF 0 785 SF		BASE INCENTIVES (3):		
STUDIO 0 1 100 SF 0 361 SF 3RD FL FFE STUDIO 0 1 100 SF 0 361 SF 4TH FL FFE STUDIO 0 1 100 SF 0 361 SF 5TH FL FFE		ZERO PARKING WHEN WITHIN 1/2 MILE OF UNLIMITED DENSITY PER AB1763	MAJOR TRANSIT STOP PER AB1763	
STUDIO 0 1 100 SF 0 361 SF 6TH FL FFE STUDIO 0 1 100 SF 0 361 SF 7TH FL FFE STUDIO: 5 5 500 SF 0 1,803 SF		ADDITIONAL INCENTIVES (5): 20% REDUCTION IN SIDE YARD PER LAMC	12.22.A.25	
Grand total: 200 20,625 SF 0 83,739 SF		20% FRONT YARD REDUCTION PER LAMC 58.7% REDUCTION IN REQUIRED OPEN SPA	12.22.A.25 ACE PER LAMC 12.22.A.25	
		WAIVER OF DEVELOPMENT STANDARDS WAIVER TO ALLOW 26.4% REDUCTION IN B WAIVER OF HEIGHT REQUIREMENT TO ALL	BICYCLE PARKING	
		WAIVER OF FAR/RFAR REQUIREMENT TO A WAIVER OF R-1 ENCROACHMENT PLANE R	ALLOW 782% INCREASE IN RFAR	©2022, JEFF ZBIKOWSKI ARCHITECTURE ALL DESIGNS, IDEAS, ARRANGEMENTS AND PLANS INDICATED BY
	BUILDING CODES USED			THESE DRAWINGS ARE THE PROPERTY AND COPYRIGHT OF THE ARCHITECT AND SHALL NEITHER BE USED ON ANY OTHER WORK. BE DISCLOSED TO ANY OTHER PERSON FOR ANY USE WHATSOEV WITHOUT WRITTEN PERMISSION OF THE ARCHITECT.
	2023 LOS ANGELES MUNICIPAL CODE (LAMC) 2022 CALIFORNIA FIRE CODE (CFC) 2022 CALIFORNIA BUILDING CODE (CBC) 2022 CALIFORNIA RESIDENTIAL CODE (CRC)			CLIENT NAME: UNCOMMON DEVELOPERS
	2022 CALIFORNIA ELECTRICAL CODE (CEC) 2022 CALIFORNIA GREEN BUILDING CODE (CGBC)			9220 N WINNETKA AVE CHATSWORTH, CA 91311
	2022 CALIFORNIA MECHANICAL CODE (CMC) 2022 CALIFORNIA PLUMBING CODE (CPC)			PROJECT NAME: UNCOMMON
	SEPARATE PERMITS	VICINITY MAP		ETHEL
	MECHANICAL FIRE SPRINKLER SYSTEM		2 5	NOT FOR CONSTRUCTION
	ELECTRICAL BLOCK WALL PLUMBING		50	PROJECT ADDRESS: 5511 N ETHEL AVE SHERMAN OAKS, CA
	FIRE ALARM SYSTEM			JOB NUMBER:
			5511 N ETHEL AVE APN: 2345-005-016	DATE: 5.31.2023
	DEFERRED SUBMITTALS	VI B 19	34	SHEET TITLE: PROJECT
		127.80 WEST	MLINE LST 118 50 251.26 TR NO.1080 20	INFORMATION
	FIRE ALARM SYSTEM	1.62	ERS STE & PG	
	FIRE-SPRINKLER SYSTEM	#SF 1 8 R=45 \$\overline{\text{ALBI}}{32} \overline{\text{32}} \overline{\text{52.98}} \text{	50 50 36.01.65 50 11	SHEET NUMBER:
		1 1 25 47 1 1 1 1 1 1 1 1 1 1 1 1 1 1 1 1 1 1	A comparation for the comparation of the comparatio	SHEET NUMBER:
	FIRE-SPRINKLER SYSTEM MECHANICAL	#SF 1 32 1	50 50 36.01.65 50 11	SHEET NUMBER: GOOT DRAWING SET TITLE: ENTITLEMENT SET



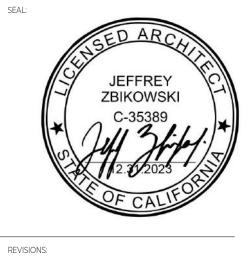





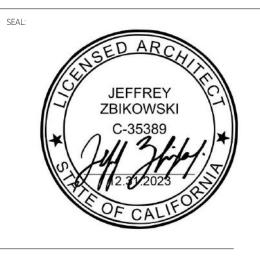

©2022, JEFF ZBIKOWSKI ARCHITECTURE

ALL DESIGNS, IDEAS, ARRANGEMENTS AND PLANS INDICATED BY THESE DRAWINGS ARE THE PROPERTY AND COPYRIGHT OF THE ARCHITECT AND SHALL NEITHER BE USED ON ANY OTHER WORK NOR BE DISCLOSED TO ANY OTHER PERSON FOR ANY USE WHATSOEVER WITHOUT WRITTEN PERMISSION OF THE ARCHITECT. UNCOMMON DEVELOPERS

9220 N WINNETKA AVE CHATSWORTH, CA 91311 UNCOMMON

NOT FOR CONSTRUCTION

5511 N ETHEL AVE

SHERMAN OAKS, CA

SITE PHOTOS &
EXISTING CONDITIONS


G002







JEFF ZBIKOWSKI ARCHITECTURE 4043 IRVING PL, SUITE B CULVER CITY, CA 90232 www.jzarch.la // 310.853.5004 INFO@JZARCH.LA

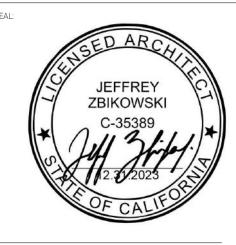

NTS NTS **CORNER VIEW** CORNER VIEW



©2022, JEFF ZBIKOWSKI ARCHITECTURE ALL DESIGNS, IDEAS, ARRANGEMENTS AND PLANS INDICATED BY THESE DRAWINGS ARE THE PROPERTY AND COPYRIGHT OF THE ARCHITECT AND SHALL NEITHER BE USED ON ANY OTHER WORK NOR BE DISCLOSED TO ANY OTHER PERSON FOR ANY USE WHATSOEVER WITHOUT WRITTEN PERMISSION OF THE ARCHITECT.

UNCOMMON DEVELOPERS 9220 N WINNETKA AVE CHATSWORTH, CA 91311

UNCOMMON

NOT FOR CONSTRUCTION PROJECT ADDRESS:

5511 N ETHEL AVE SHERMAN OAKS, CA

PROJECT NAME:

DATE:
5.31.2023
SHEET TITLE:
RENDERINGS

SHEET NUMBER:



2,020 SF 152,677 SF

GRAND TOTAL

©2022, JEFF ZBIKOWSKI ARCHITECTURE ALL DESIGNS, IDEAS, ARRANGEMENTS AND PLANS INDICATED BY THESE DRAWINGS ARE THE PROPERTY AND COPYRIGHT OF THE ARCHITECT AND SHALL NEITHER BE USED ON ANY OTHER WORK NOR BE DISCLOSED TO ANY OTHER PERSON FOR ANY USE WHATSOEVER WITHOUT WRITTEN PERMISSION OF THE ARCHITECT.

UNCOMMON DEVELOPERS 9220 N WINNETKA AVE CHATSWORTH, CA 91311

UNCOMMON

NOT FOR CONSTRUCTION

5511 N ETHEL AVE SHERMAN OAKS, CA

DATE: 5.31.2023

SHEET TITLE:
GROSS AREA **CALCULATIONS**

G009

DRAWING SETTITLE:
ENTITLEMENT SET

6TH FL DIAGRAM 1" = 30'-0" 6 3RD FL DIAGRAM 1" = 30'-0" 3



©2022, JEFF ZBIKOWSKI ARCHITECTURE ALL DESIGNS, IDEAS, ARRANGEMENTS AND PLANS INDICATED BY THESE DRAWINGS ARE THE PROPERTY AND COPYRIGHT OF THE ARCHITECT AND SHALL NEITHER BE USED ON ANY OTHER WORK NOR BE DISCLOSED TO ANY OTHER PERSON FOR ANY USE WHATSOEVER WITHOUT WRITTEN PERMISSION OF THE ARCHITECT.

UNCOMMON DEVELOPERS 9220 N WINNETKA AVE CHATSWORTH, CA 91311

UNCOMMON

NOT FOR CONSTRUCTION

5511 N ETHEL AVE SHERMAN OAKS, CA

SHEET TITLE:
ZONING CODE AREA

G010

DRAWING SET TITLE:
ENTITLEMENT SET


1ST FLOOOR FAR DIAGRAM 1" = 30'-0" 1

4TH FLOOR FAR DIAGRAM 1" = 30'-0" 4 7TH FLOOR FAR DIAGRAM 1" = 30'-0" 7



ARCHITECTURE

ARCHITECT
JEFF ZBIKOWSKI ARCHITECTURE
4043 IRVING PL, SUITE B
CULVER CITY, CA 90232
WWW.JZARCH.LA // 310.853.5004
INFO@JZARCH.LA

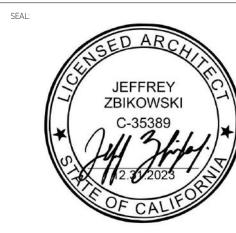

REVISIONS:

©2022, JEFF ZBIKOWSKI ARCHITECTURE

ALL DESIGNS, IDEAS, ARRANGEMENTS AND PLANS INDICATED BY THESE DRAWINGS ARE THE PROPERTY AND COPYRIGHT OF THE ARCHITECT AND SHALL NEITHER BE USED ON ANY OTHER WORK NOR BE DISCLOSED TO ANY OTHER PERSON FOR ANY USE WHATSOEVER WITHOUT WRITTEN PERMISSION OF THE ARCHITECT.

UNCOMMON DEVELOPERS
9220 N WINNETKA AVE
CHATSWORTH, CA 91311

UNCOMMON ETHEL

NOT FOR CONSTRUCTION

PROJECT ADDRESS:

5511 N ETHEL AVE SHERMAN OAKS, CA

SHERMAN OAKS DB NUMBER: 2734

DATE: 5.31.2023


OPEN SPACE
CALCULATIONS

GO12

DRAWING SET TITLE:

ENTITLEMENT SET

/2023 2:42:32 PM

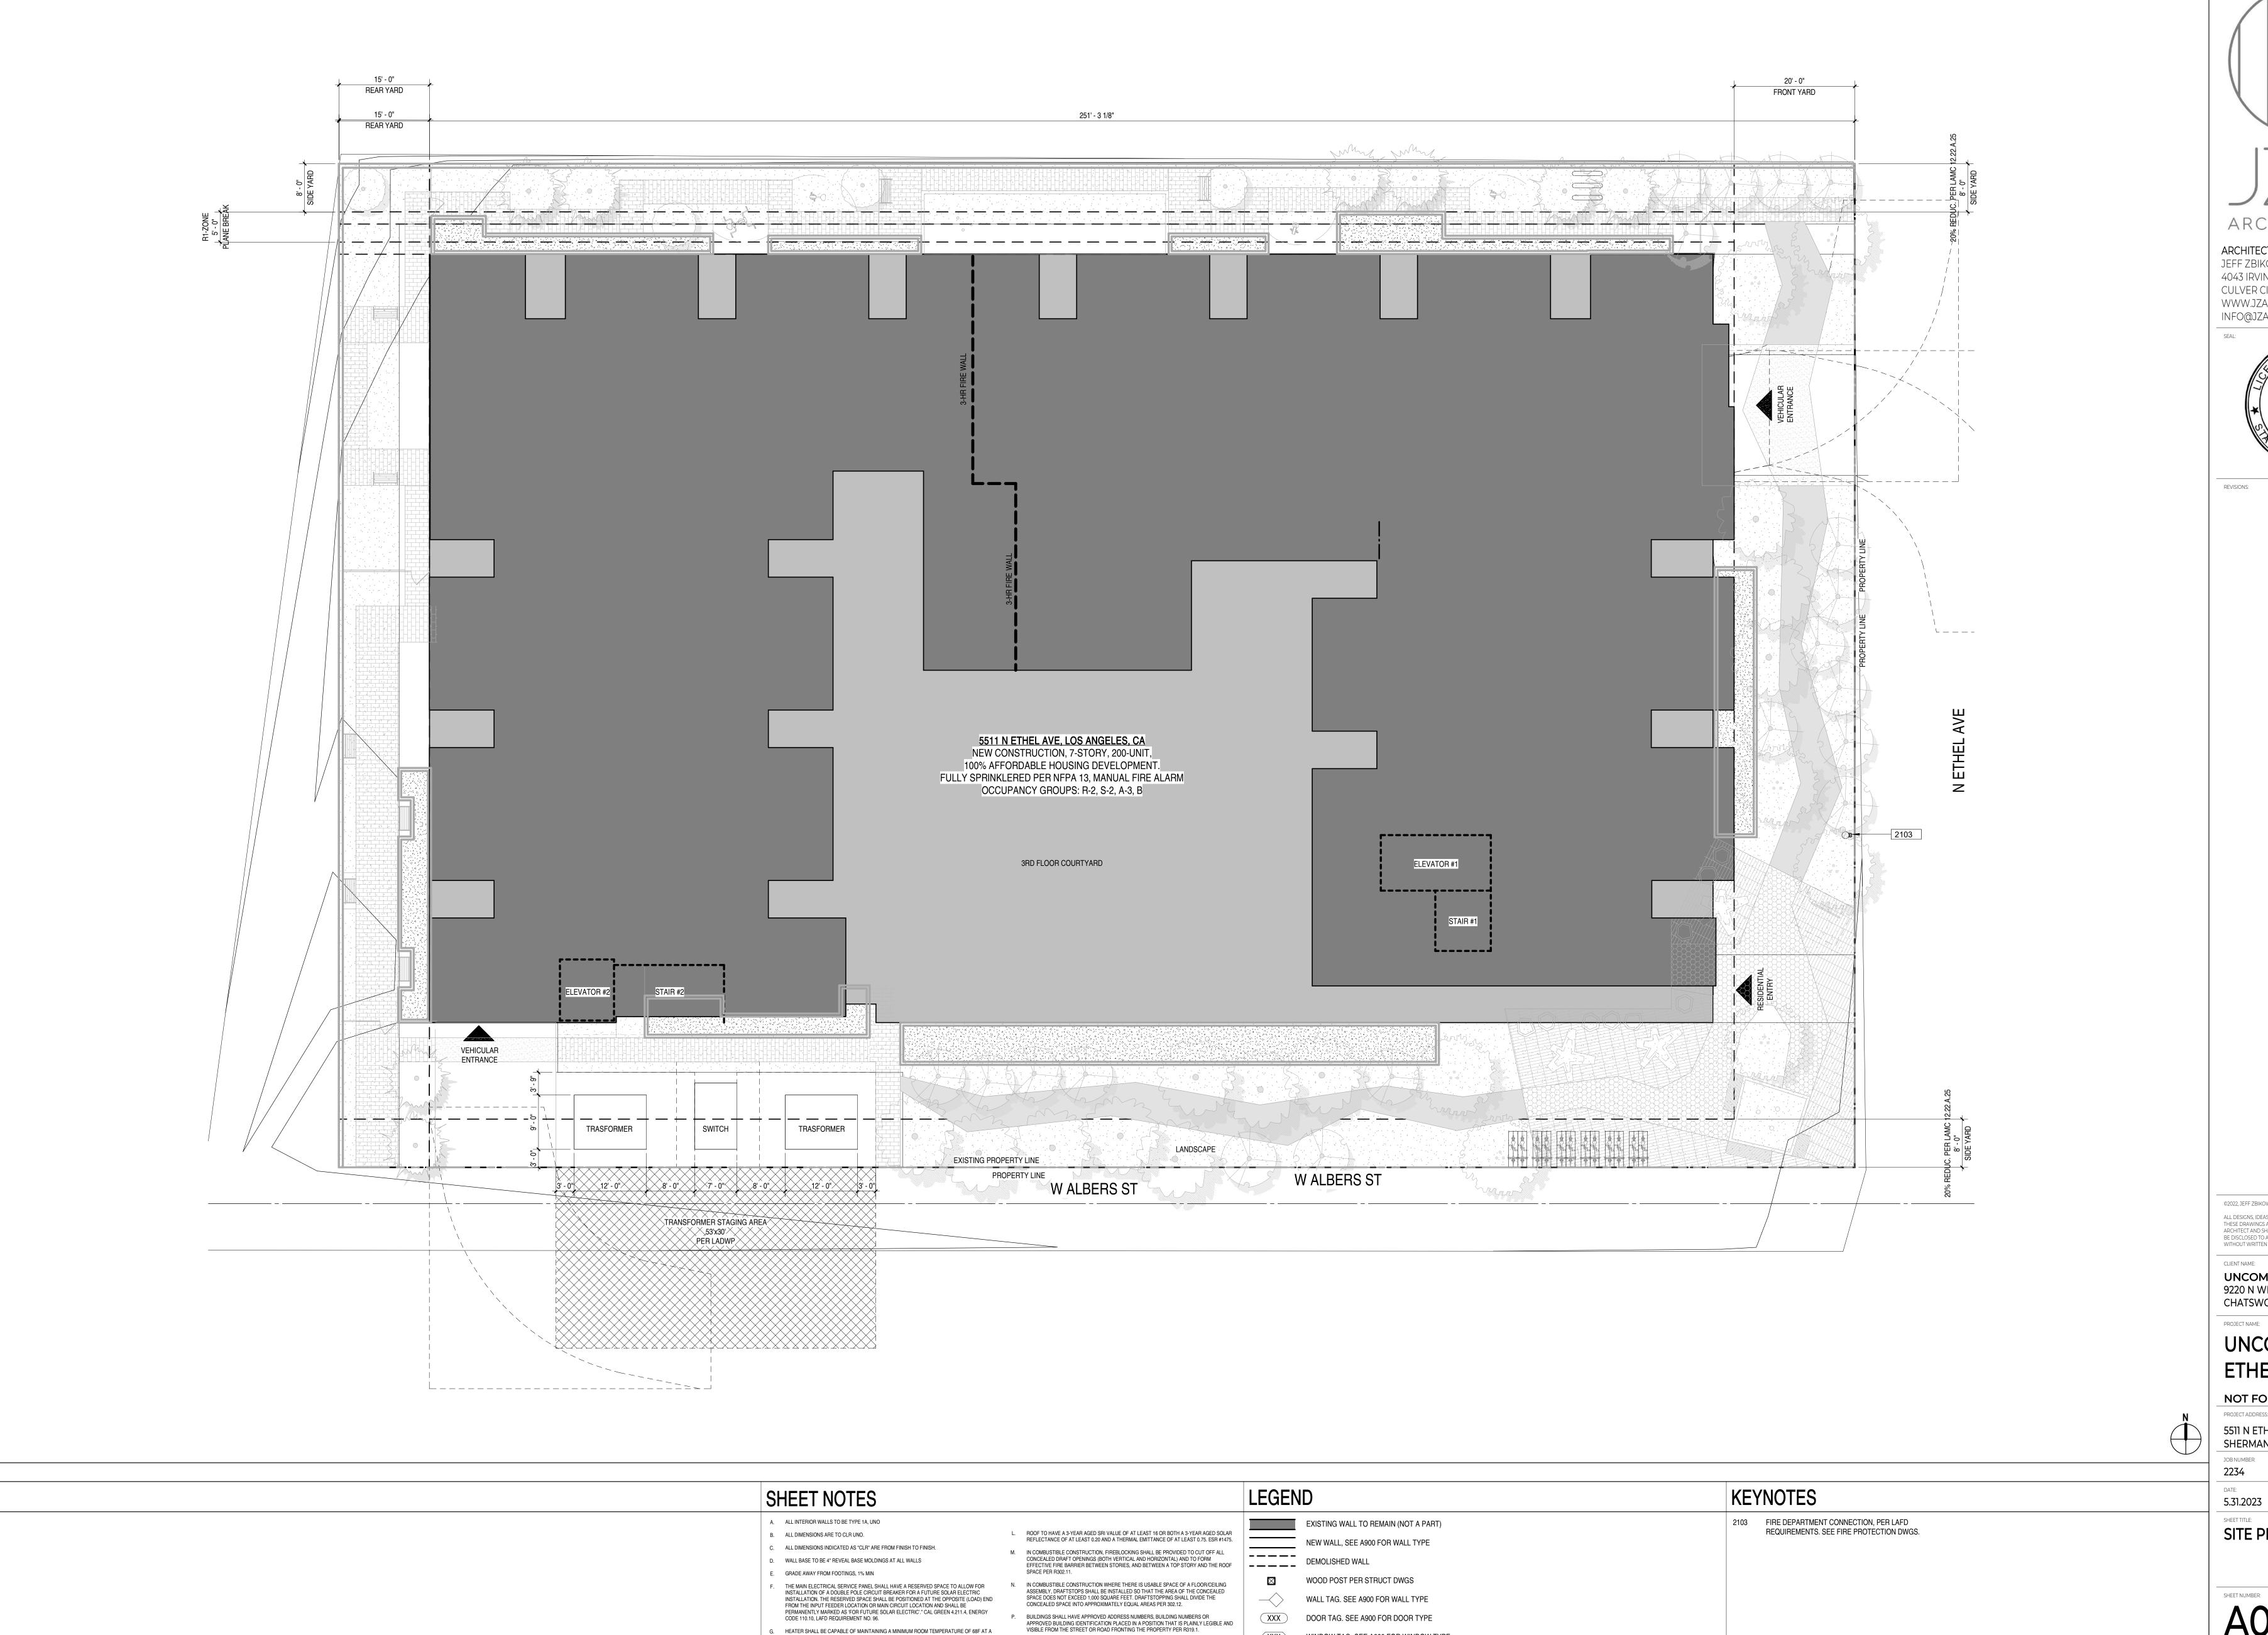

Q. PROTECTION OF WEOOD AND WOOD AGED PRODUCTS SHALL BE PROVIDED IN THE

S. PROVIDE ANTI-GRAFFITI FINISH WITHIN FIRST 9 FEET MEASURED FROM GRADE AT

R. THE USE OF NATURAL DURABLE WOOD OR WOOD THAT IS PRESERVATIVE-TREATED IN ACCORDANCE WITH AWPA U1 FOR THE SPECIES, PRODUCT, PRESERVATIVE AND END USE. PRESERVATIVES SHALL BE LISTED IN SECTION 4 OF AWPA U1.

LOCATIONS SPECIFIED PER SECTION R317.1 BY

EXTERIOR WALLS AND DOORS.

XXX WINDOW TAG. SEE A900 FOR WINDOW TYPE

CARBON MONOXIDE DETECTOR

BATHROOM EXHAUST FAN

SMOKE DETECTOR

HEATER SHALL BE CAPABLE OF MAINTAINING A MINIMUM ROOM TEMPERATURE OF 68F AT A

FIRE BLOCKING SHALL BE PROVIDED TO CUT OFF ALL CONCEALED DRAFT OPENINGS (BOTH VERTICAL AND HORIZONTAL) AND TO FORM AN EFFECTIVE FIRE BARRIER BETWEEN STORIES AND BETWEEN A TOP STORY AND THE ROOF SPACE PER R302.11


POINT 3 FEET ABOVE THE FLOOR AND 2 FEET FROM EXTERIOR WALLS IN ALL HABITABLE ROOMS AT THE DESIGN TEMPERATURE

EDGE FLASHING TO BE 18 GA GALVANIZED SHEET METAL, PAINTED TO MATCH FASCIA

ROOFING MATERIAL TO BE MALARKEY ROOFING, ECOASIS SOL PREMIUM - MESQUITE,

ARCHITECTURE

ARCHITECT JEFF ZBIKOWSKI ARCHITECTURE 4043 IRVING PL, SUITE B CULVER CITY, CA 90232 WWW.JZARCH.LA // 310.853.5004 INFO@JZARCH.LA

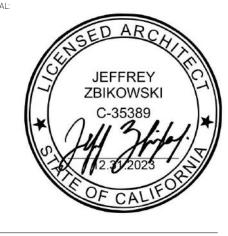

©2022, JEFF ZBIKOWSKI ARCHITECTURE ALL DESIGNS, IDEAS, ARRANGEMENTS AND PLANS INDICATED BY THESE DRAWINGS ARE THE PROPERTY AND COPYRIGHT OF THE ARCHITECT AND SHALL NEITHER BE USED ON ANY OTHER WORK NOR BE DISCLOSED TO ANY OTHER PERSON FOR ANY USE WHATSOEVER WITHOUT WRITTEN PERMISSION OF THE ARCHITECT.

UNCOMMON DEVELOPERS 9220 N WINNETKA AVE CHATSWORTH, CA 91311


UNCOMMON ETHEL

NOT FOR CONSTRUCTION

PROJECT ADDRESS: 5511 N ETHEL AVE SHERMAN OAKS, CA

SITE PLAN

ENTITLEMENT SET

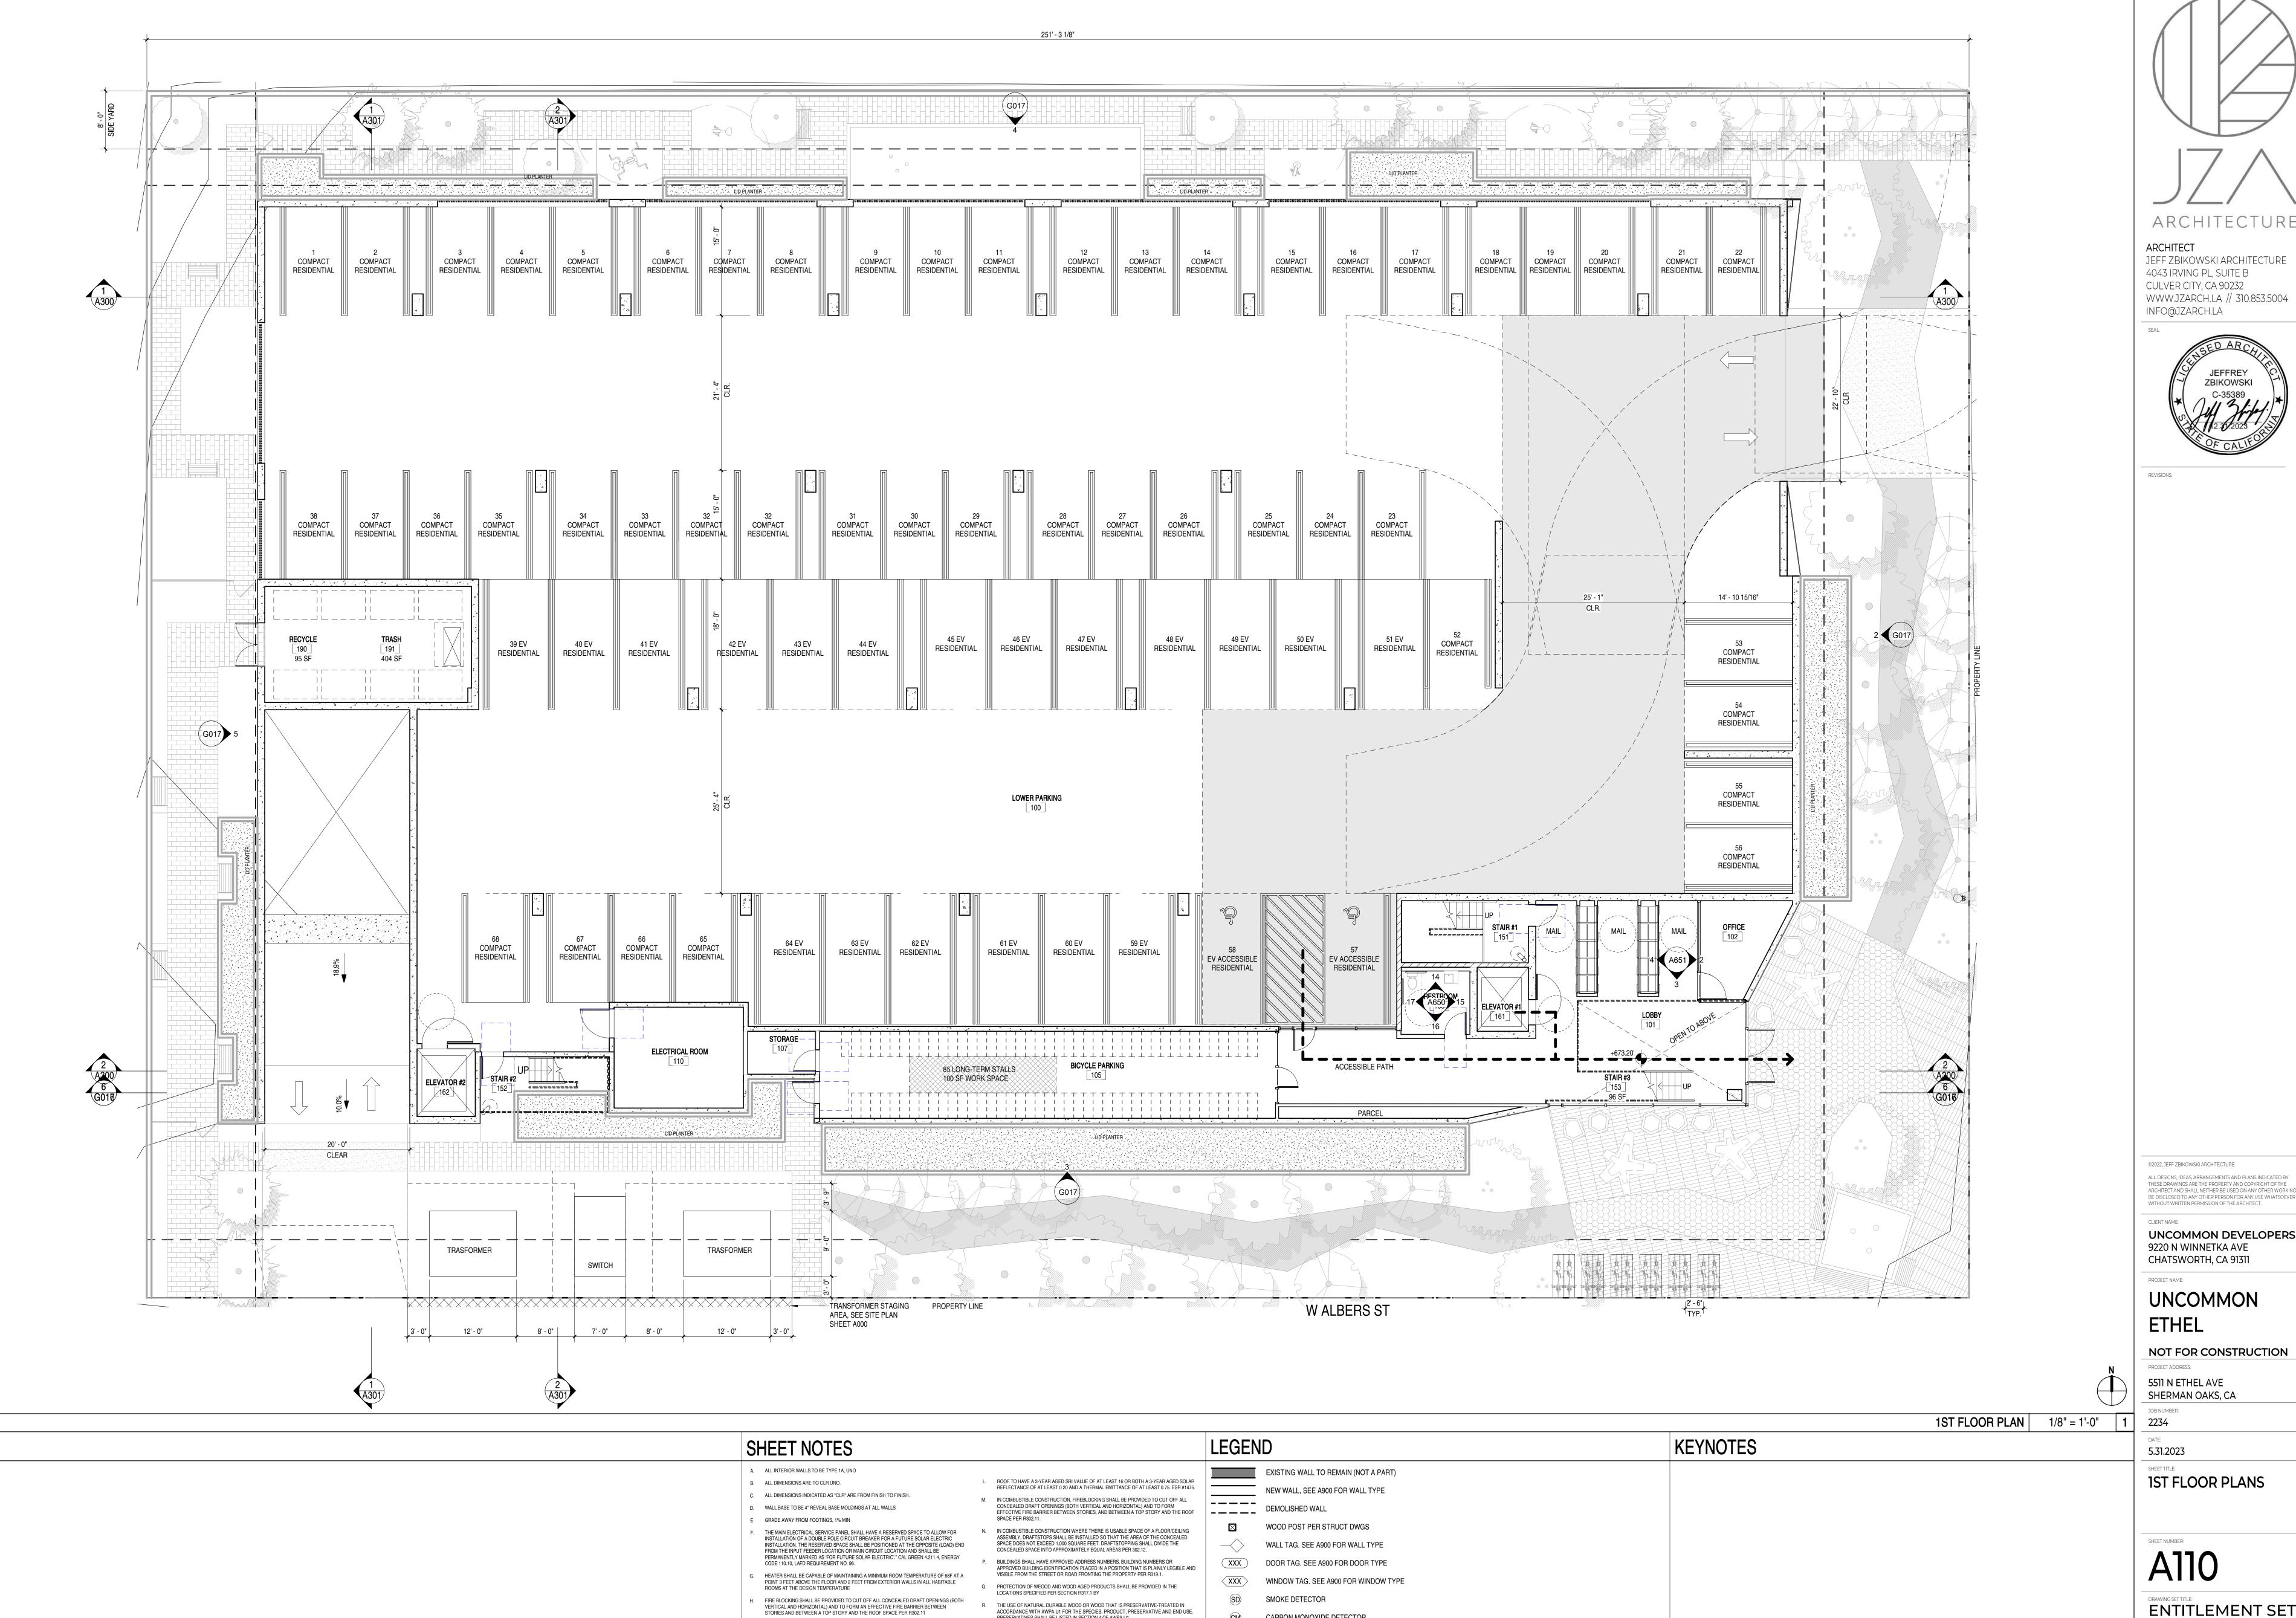

PRESERVATIVES SHALL BE LISTED IN SECTION 4 OF AWPA U1.

EXTERIOR WALLS AND DOORS.

S. PROVIDE ANTI-GRAFFITI FINISH WITHIN FIRST 9 FEET MEASURED FROM GRADE AT

EDGE FLASHING TO BE 18 GA GALVANIZED SHEET METAL, PAINTED TO MATCH FASCIA

ROOFING MATERIAL TO BE MALARKEY ROOFING, ECOASIS SOL PREMIUM - MESQUITE,

CARBON MONOXIDE DETECTOR

BATHROOM EXHAUST FAN

JEFF ZBIKOWSKI ARCHITECTURE 4043 IRVING PL, SUITE B CULVER CITY, CA 90232 WWW.JZARCH.LA // 310.853.5004




ALL DESIGNS, IDEAS, ARRANGEMENTS AND PLANS INDICATED BY THESE DRAWINGS ARE THE PROPERTY AND COPYRIGHT OF THE ARCHITECT AND SHALL NEITHER BE USED ON ANY OTHER WORK NOR


UNCOMMON DEVELOPERS 9220 N WINNETKA AVE

UNCOMMON

NOT FOR CONSTRUCTION

1ST FLOOR PLANS

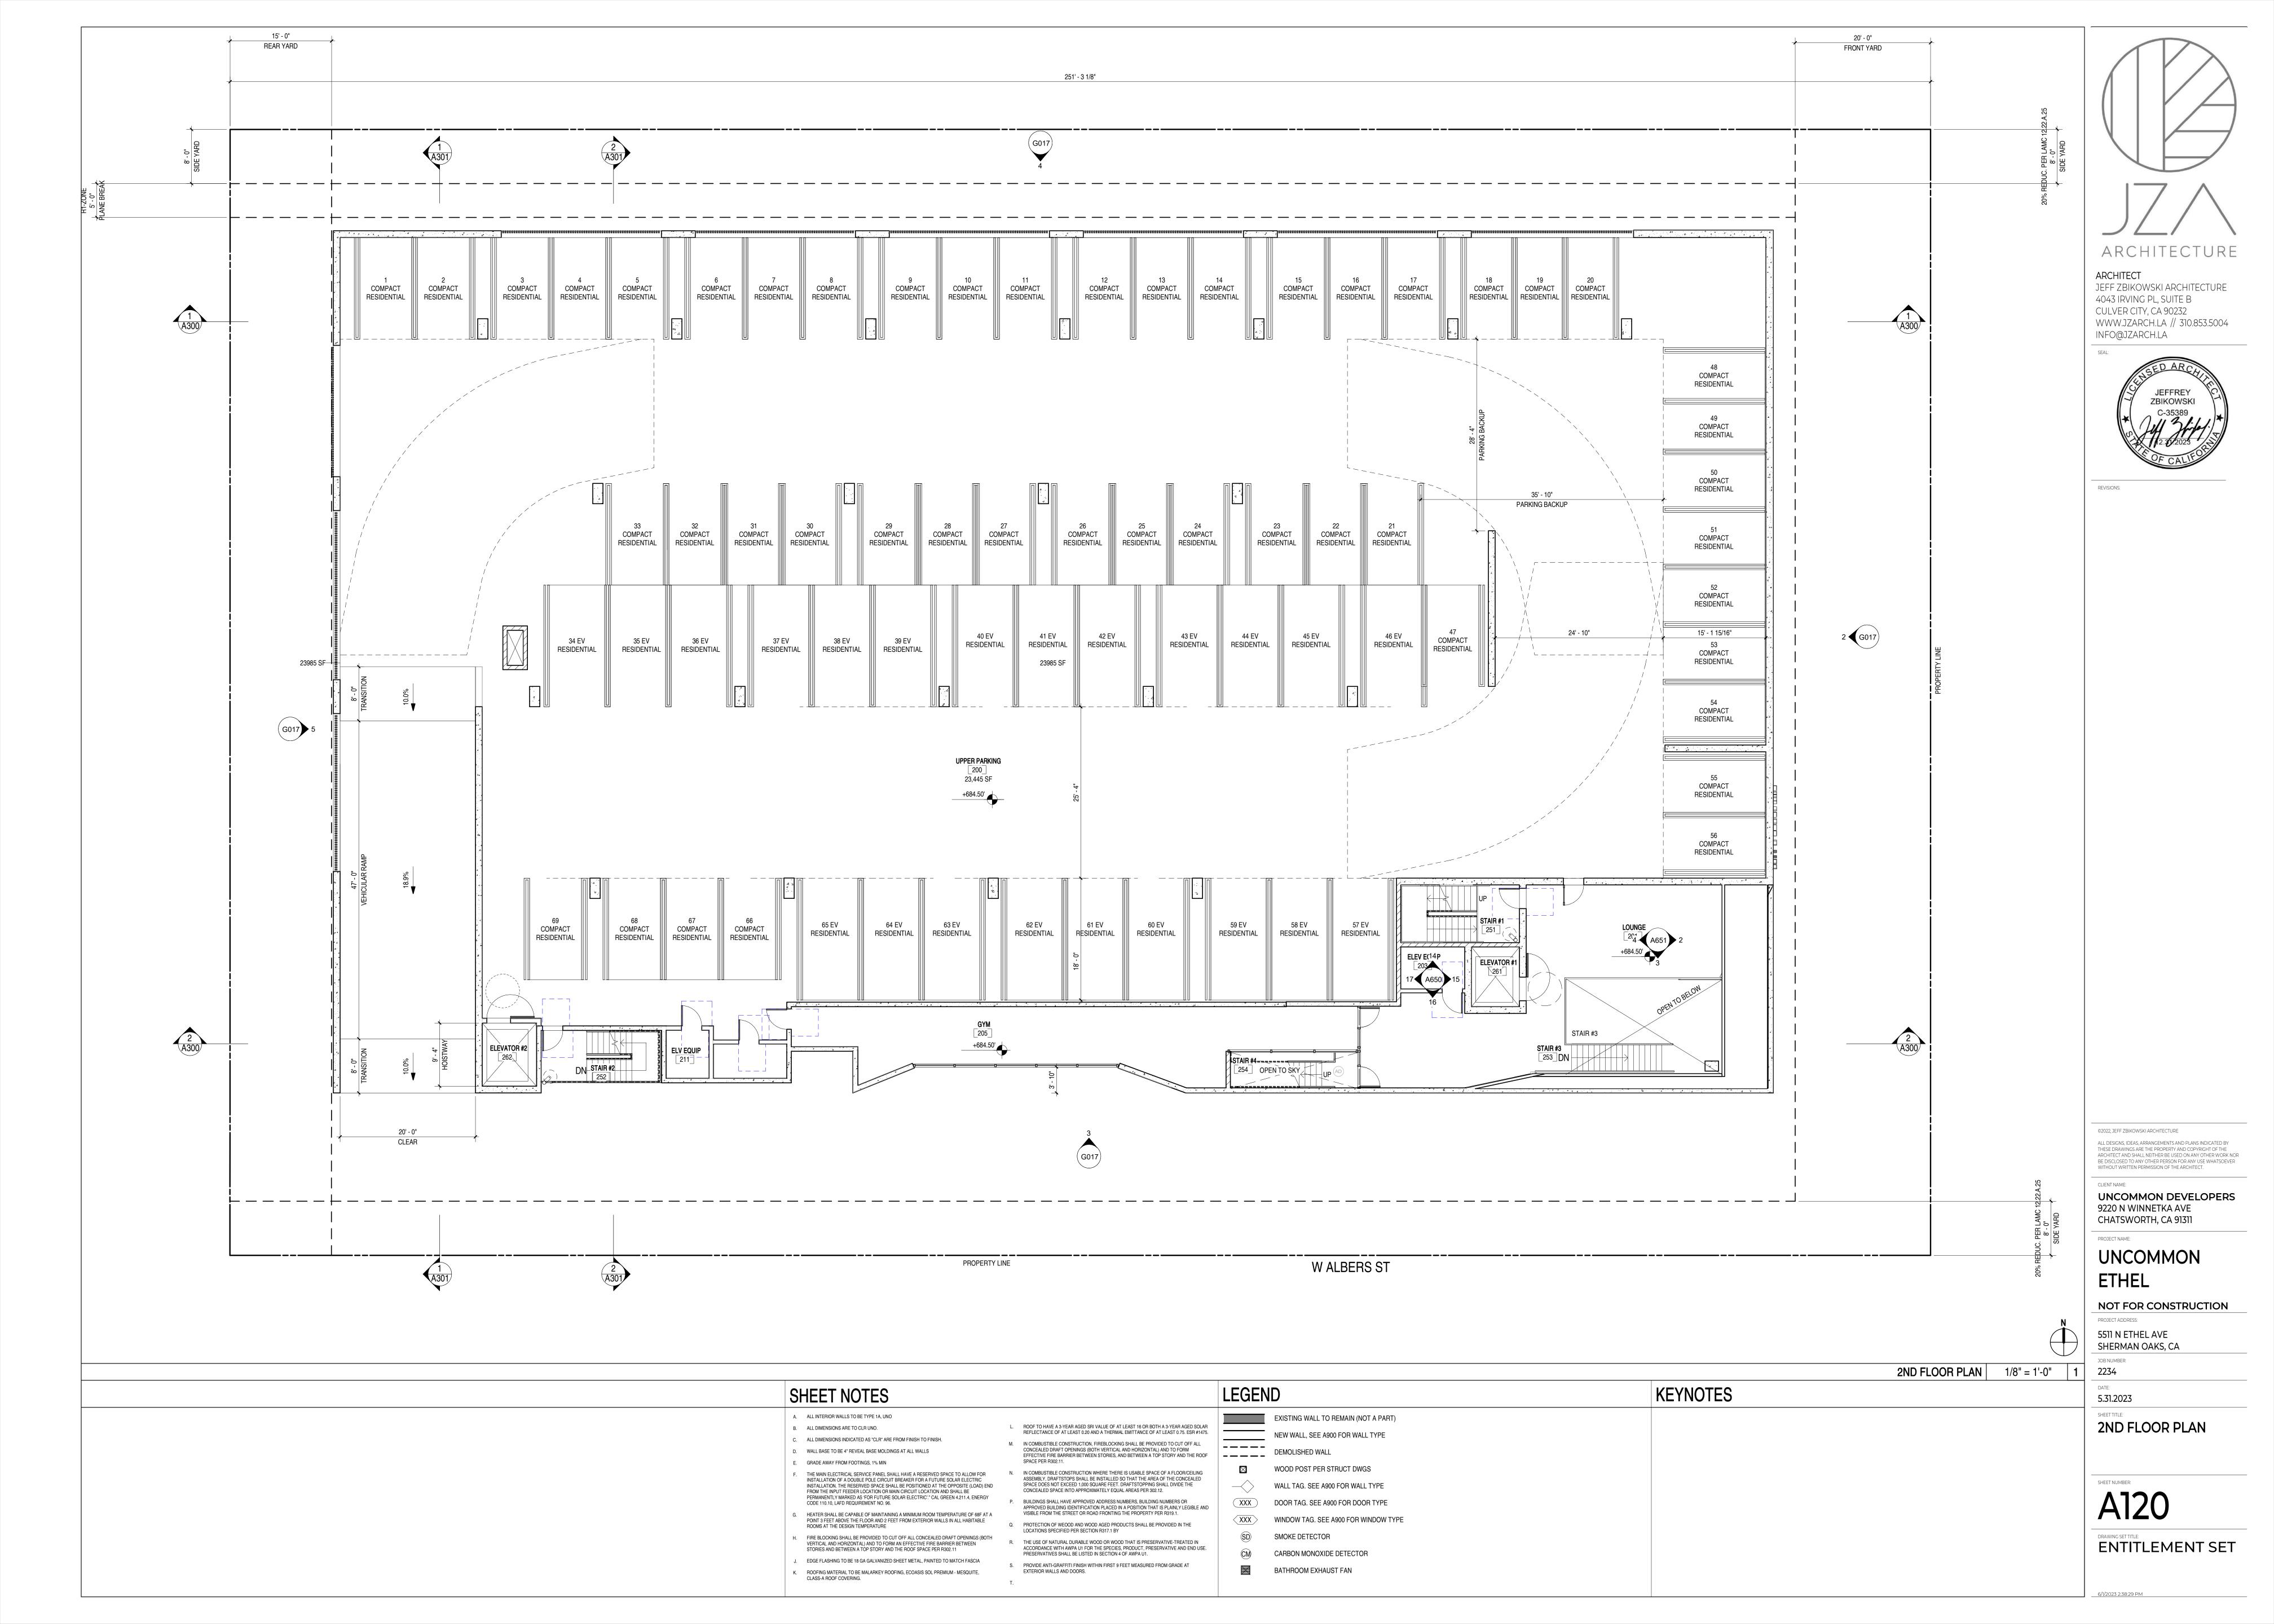

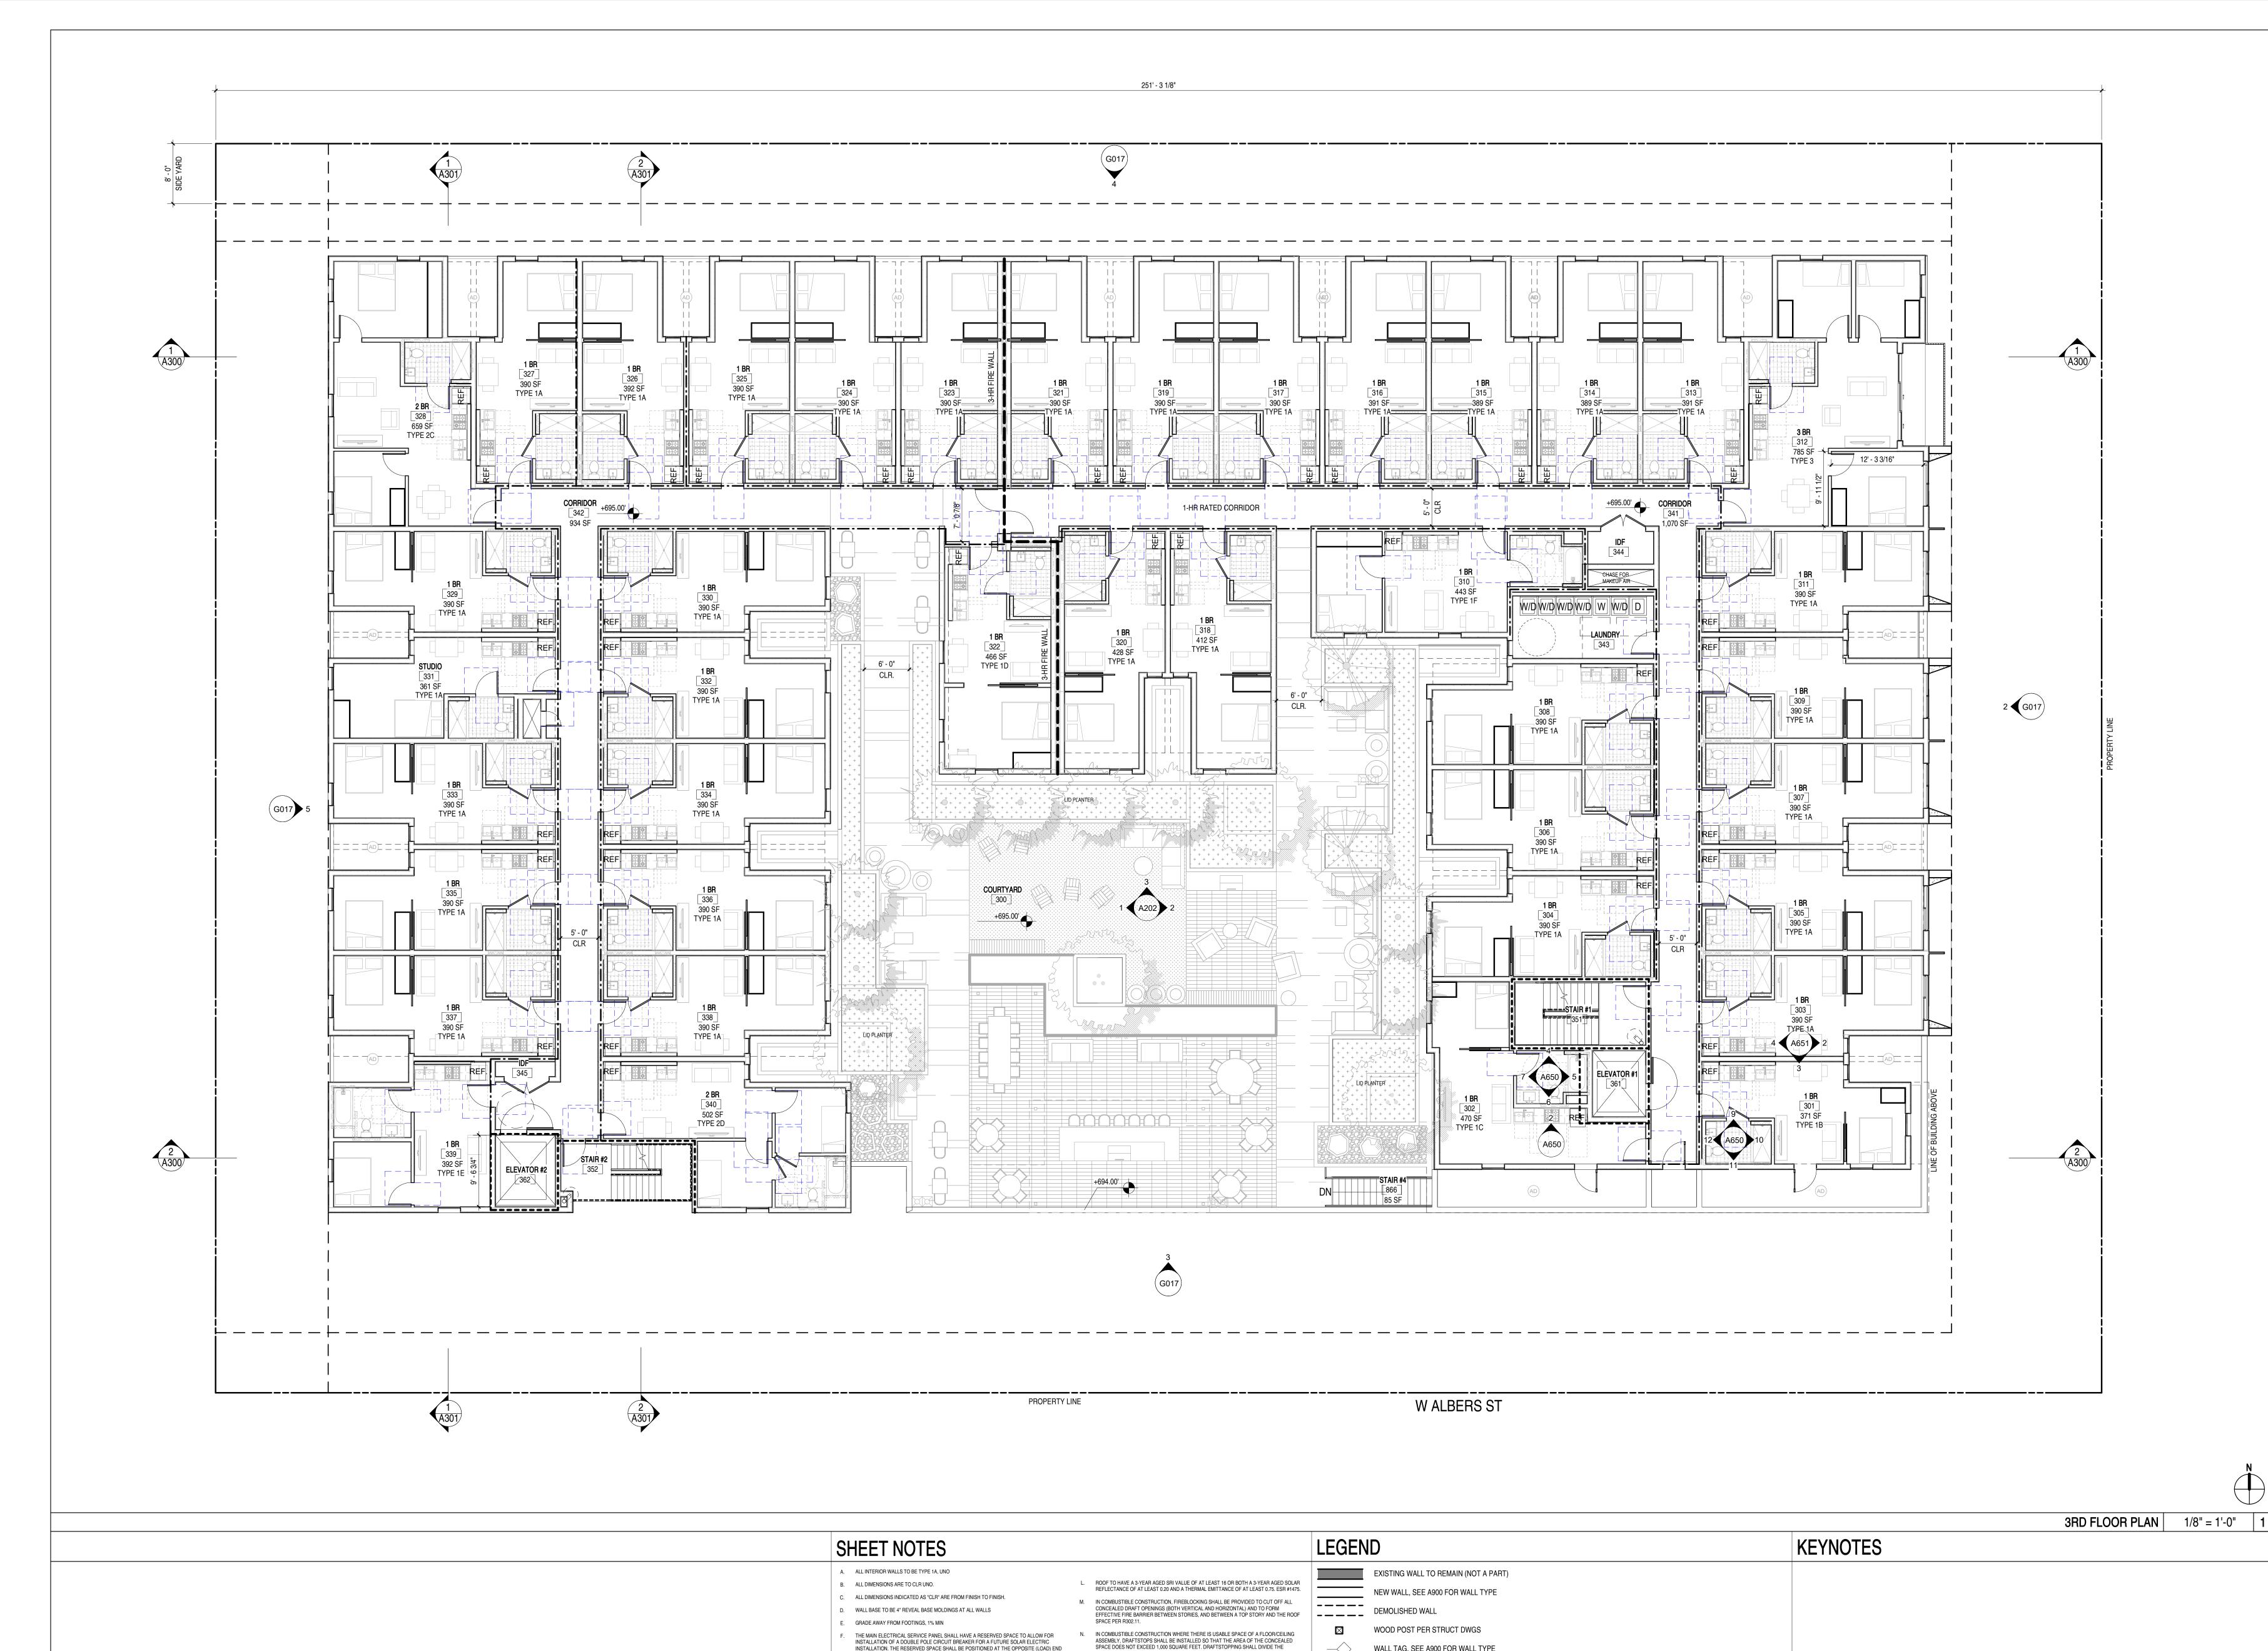

CONCEALED SPACE INTO APPROXIMATELY EQUAL AREAS PER 302.12.

Q. PROTECTION OF WEOOD AND WOOD AGED PRODUCTS SHALL BE PROVIDED IN THE

S. PROVIDE ANTI-GRAFFITI FINISH WITHIN FIRST 9 FEET MEASURED FROM GRADE AT

R. THE USE OF NATURAL DURABLE WOOD OR WOOD THAT IS PRESERVATIVE-TREATED IN ACCORDANCE WITH AWPA U1 FOR THE SPECIES, PRODUCT, PRESERVATIVE AND END USE. PRESERVATIVES SHALL BE LISTED IN SECTION 4 OF AWPA U1.

LOCATIONS SPECIFIED PER SECTION R317.1 BY

EXTERIOR WALLS AND DOORS.

BUILDINGS SHALL HAVE APPROVED ADDRESS NUMBERS, BUILDING NUMBERS OR APPROVED BUILDING IDENTIFICATION PLACED IN A POSITION THAT IS PLAINLY LEGIBLE AND VISIBLE FROM THE STREET OR ROAD FRONTING THE PROPERTY PER R319.1.

WALL TAG. SEE A900 FOR WALL TYPE

XXX DOOR TAG. SEE A900 FOR DOOR TYPE

SMOKE DETECTOR

XXX WINDOW TAG. SEE A900 FOR WINDOW TYPE

CARBON MONOXIDE DETECTOR

BATHROOM EXHAUST FAN

INSTALLATION. THE RESERVED SPACE SHALL BE POSITIONED AT THE OPPOSITE (LOAD) END FROM THE INPUT FEEDER LOCATION OR MAIN CIRCUIT LOCATION AND SHALL BE

PERMANENTLY MARKED AS "FOR FUTURE SOLAR ELECTRIC"." CAL GREEN 4.211.4, ENERGY CODE 110.10, LAFD REQUIREMENT NO. 96.

HEATER SHALL BE CAPABLE OF MAINTAINING A MINIMUM ROOM TEMPERATURE OF 68F AT A

FIRE BLOCKING SHALL BE PROVIDED TO CUT OFF ALL CONCEALED DRAFT OPENINGS (BOTH VERTICAL AND HORIZONTAL) AND TO FORM AN EFFECTIVE FIRE BARRIER BETWEEN STORIES AND BETWEEN A TOP STORY AND THE ROOF SPACE PER R302.11


POINT 3 FEET ABOVE THE FLOOR AND 2 FEET FROM EXTERIOR WALLS IN ALL HABITABLE ROOMS AT THE DESIGN TEMPERATURE

EDGE FLASHING TO BE 18 GA GALVANIZED SHEET METAL, PAINTED TO MATCH FASCIA

ROOFING MATERIAL TO BE MALARKEY ROOFING, ECOASIS SOL PREMIUM - MESQUITE,

ARCHITECT

JEFF ZBIKOWSKI ARCHITECTURE 4043 IRVING PL, SUITE B CULVER CITY, CA 90232 WWW.JZARCH.LA // 310.853.5004 INFO@JZARCH.LA

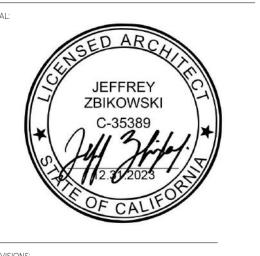

©2022, JEFF ZBIKOWSKI ARCHITECTURE ALL DESIGNS, IDEAS, ARRANGEMENTS AND PLANS INDICATED BY THESE DRAWINGS ARE THE PROPERTY AND COPYRIGHT OF THE ARCHITECT AND SHALL NEITHER BE USED ON ANY OTHER WORK NOR BE DISCLOSED TO ANY OTHER PERSON FOR ANY USE WHATSOEVER WITHOUT WRITTEN PERMISSION OF THE ARCHITECT.

UNCOMMON DEVELOPERS 9220 N WINNETKA AVE CHATSWORTH, CA 91311

PROJECT NAME: UNCOMMON ETHEL

NOT FOR CONSTRUCTION

5511 N ETHEL AVE SHERMAN OAKS, CA


JOB NUMBER:


5.31.2023

3RD FLOOR PLAN

SHEET NUMBER:


ENTITLEMENT SET

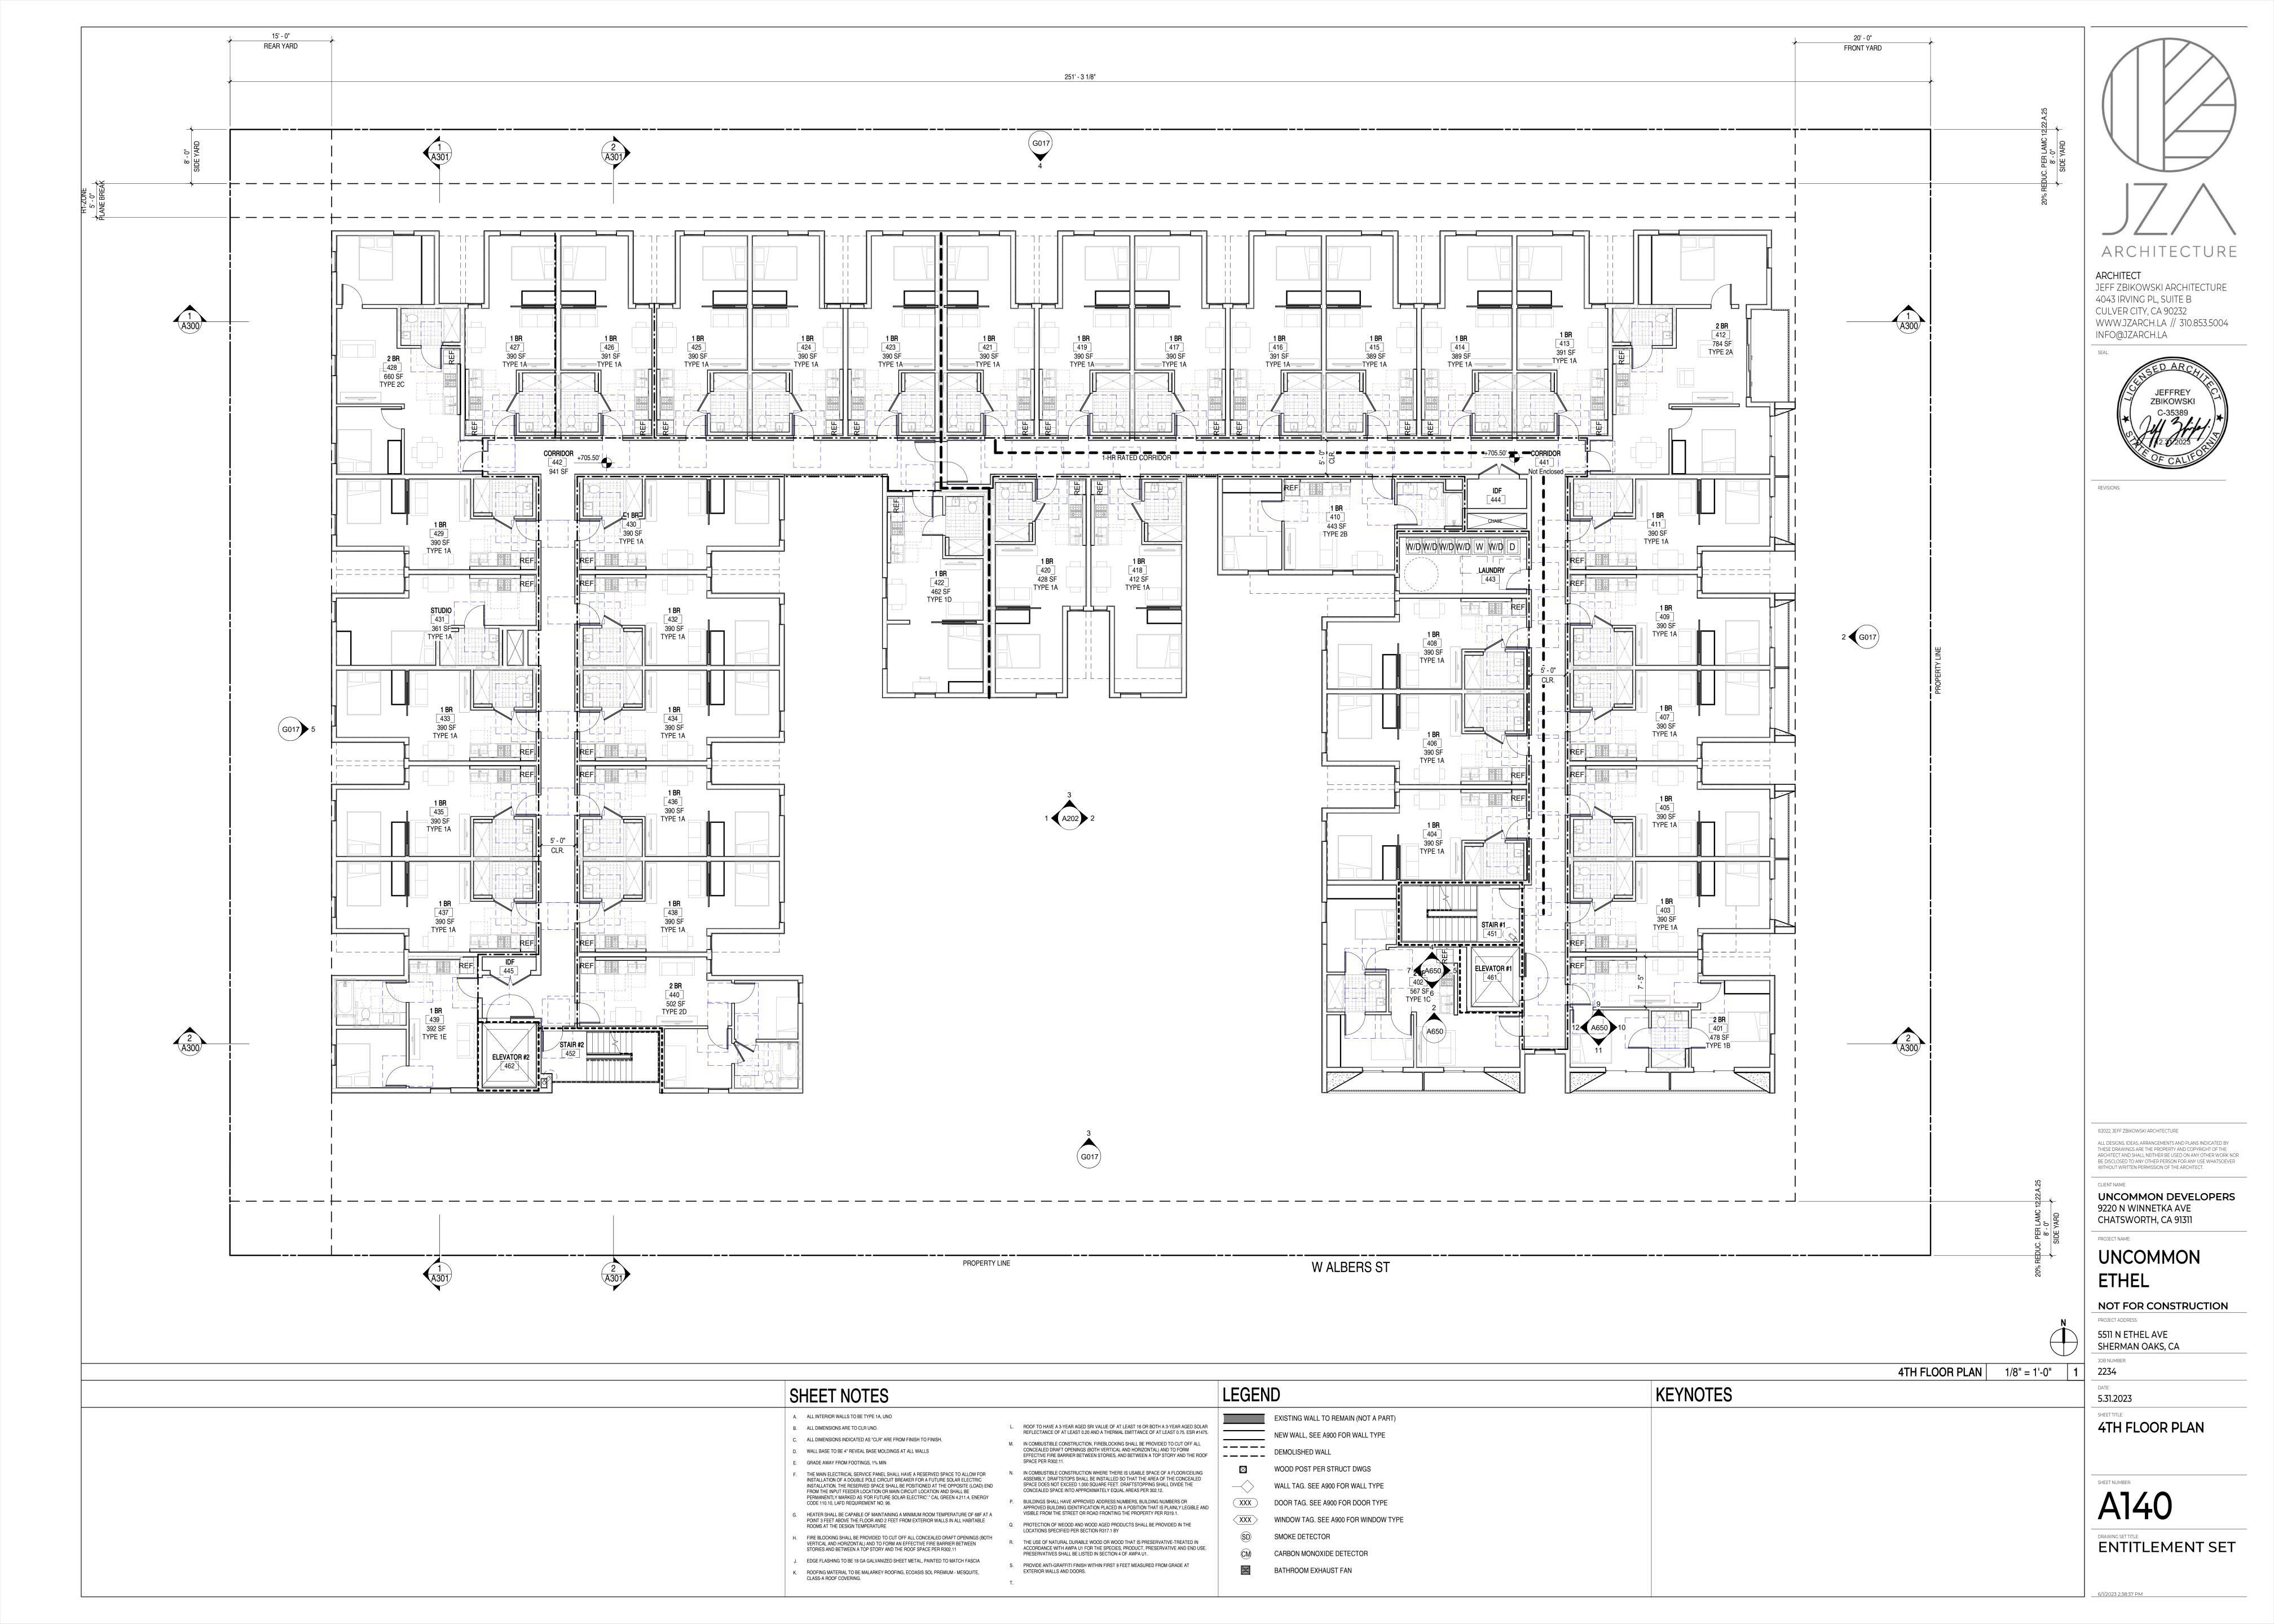

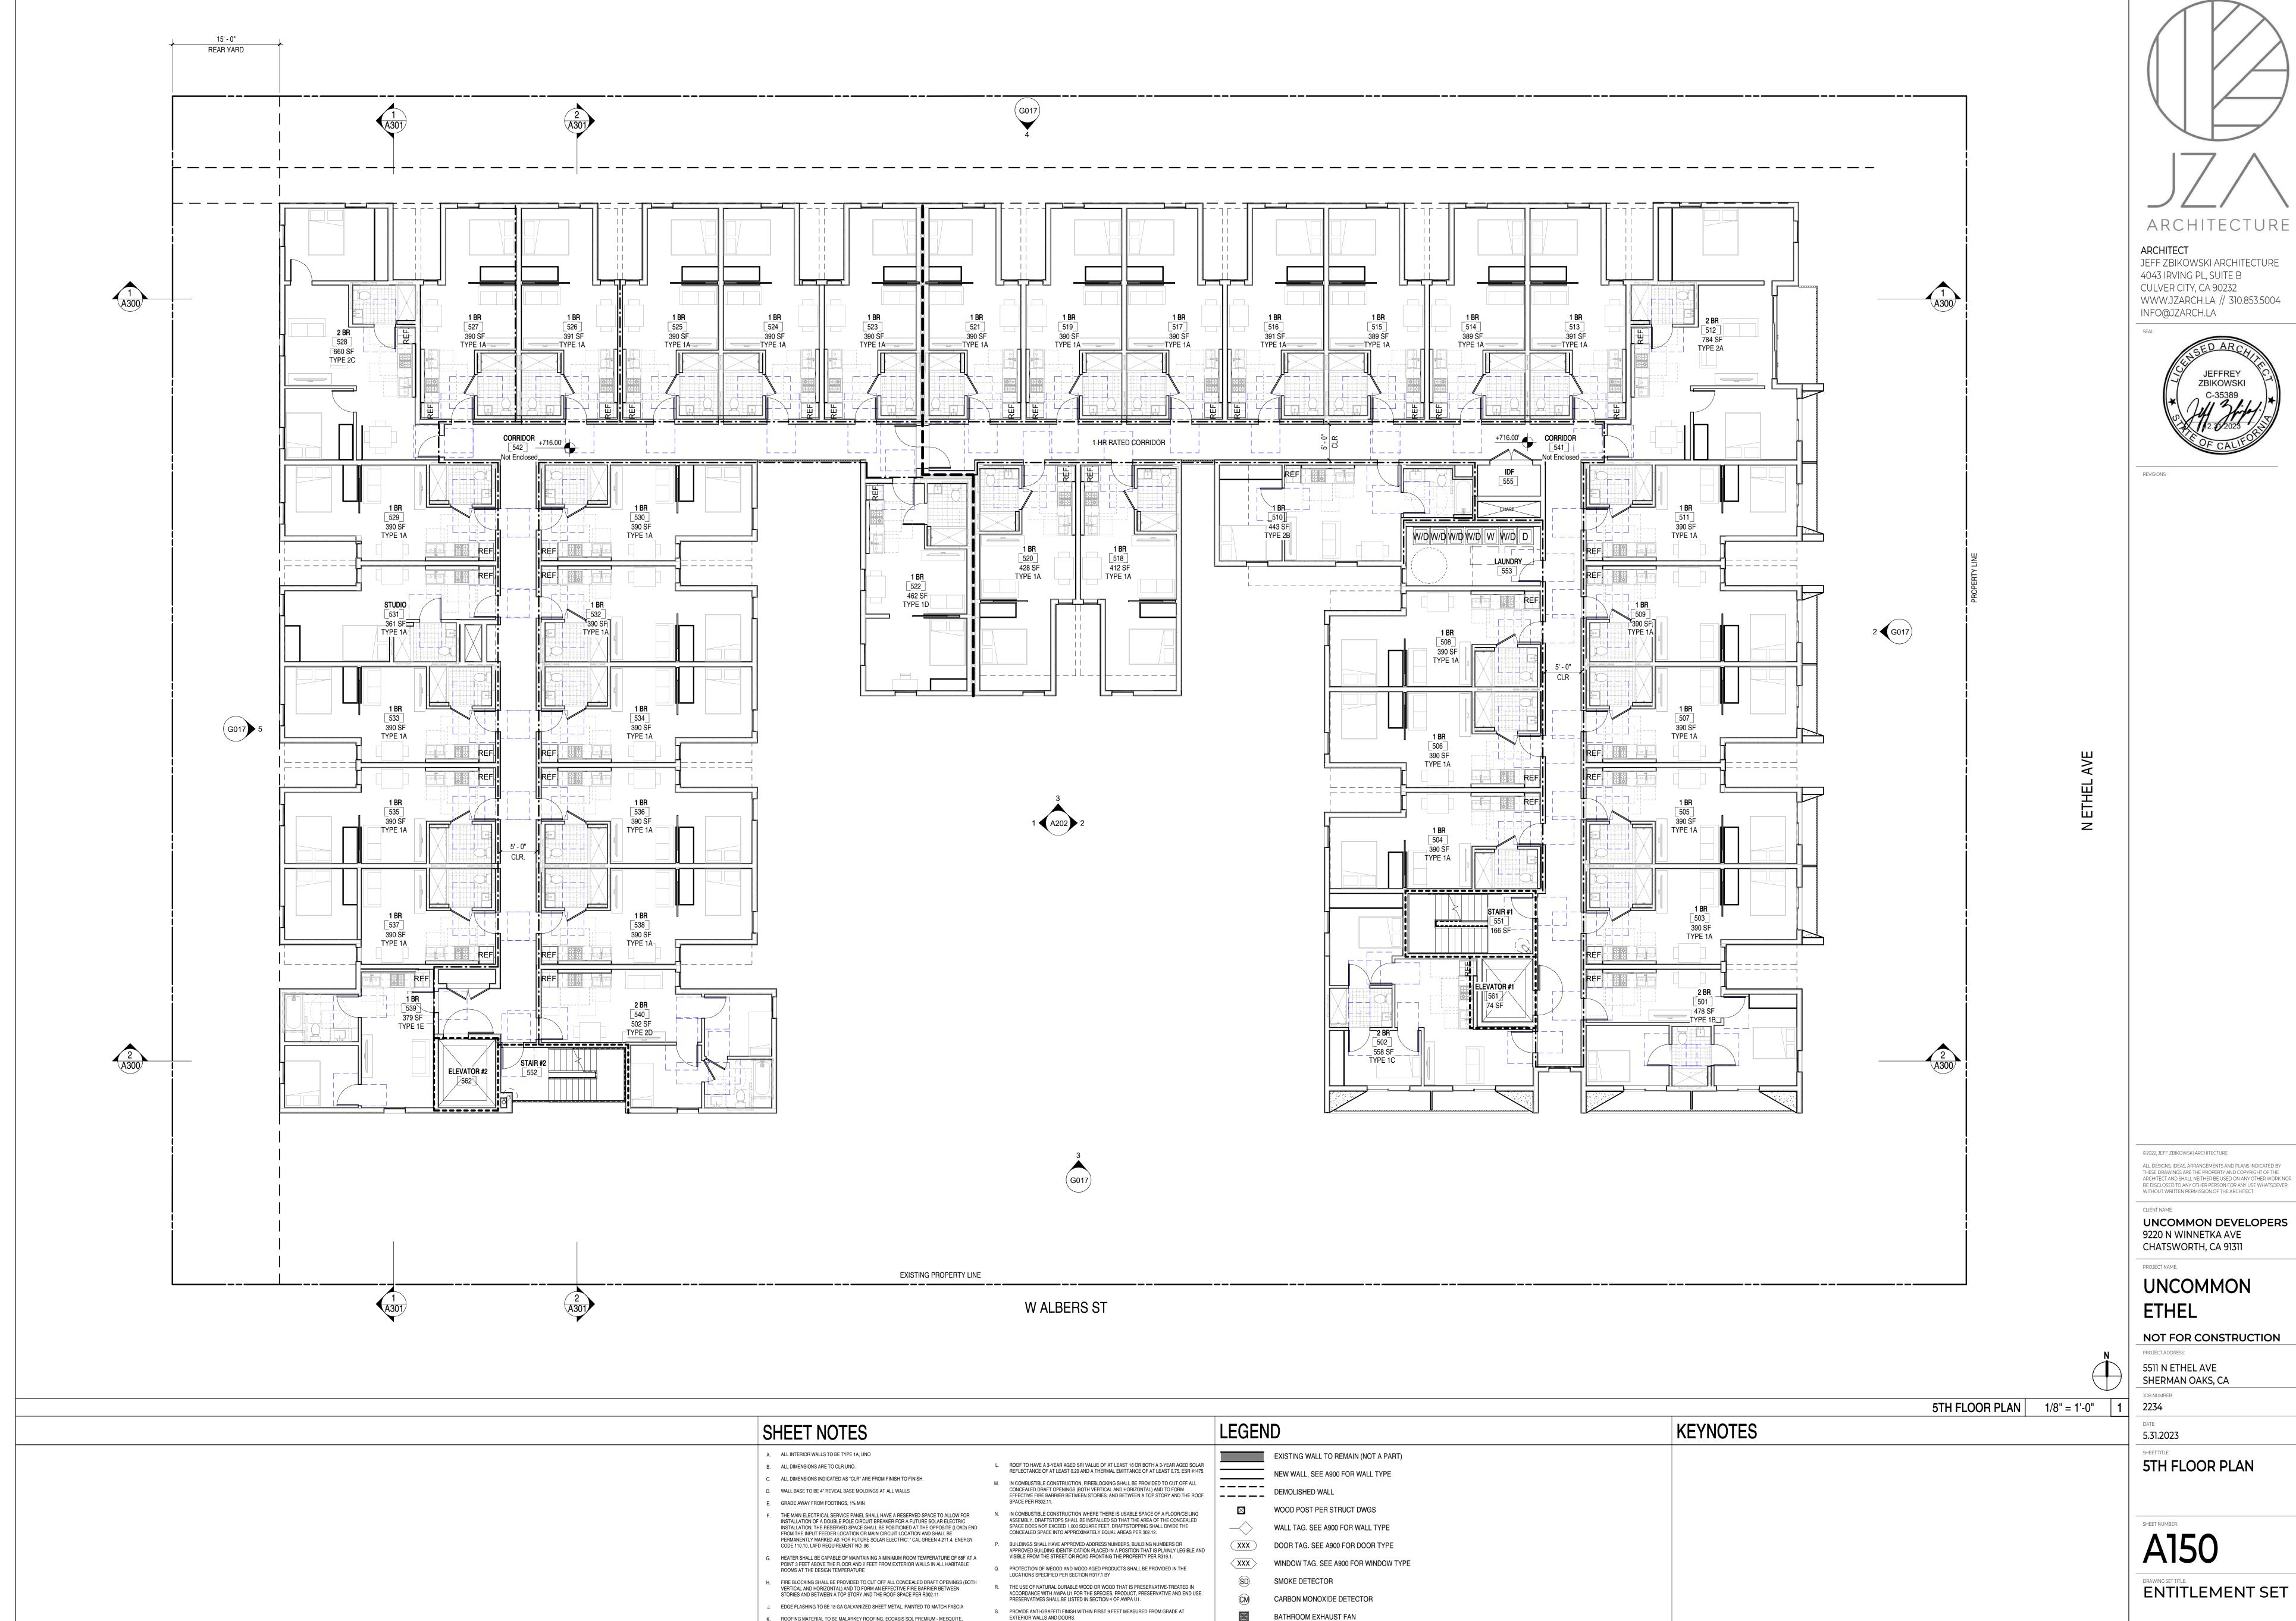

ROOFING MATERIAL TO BE MALARKEY ROOFING, ECOASIS SOL PREMIUM - MESQUITE,

EXTERIOR WALLS AND DOORS.

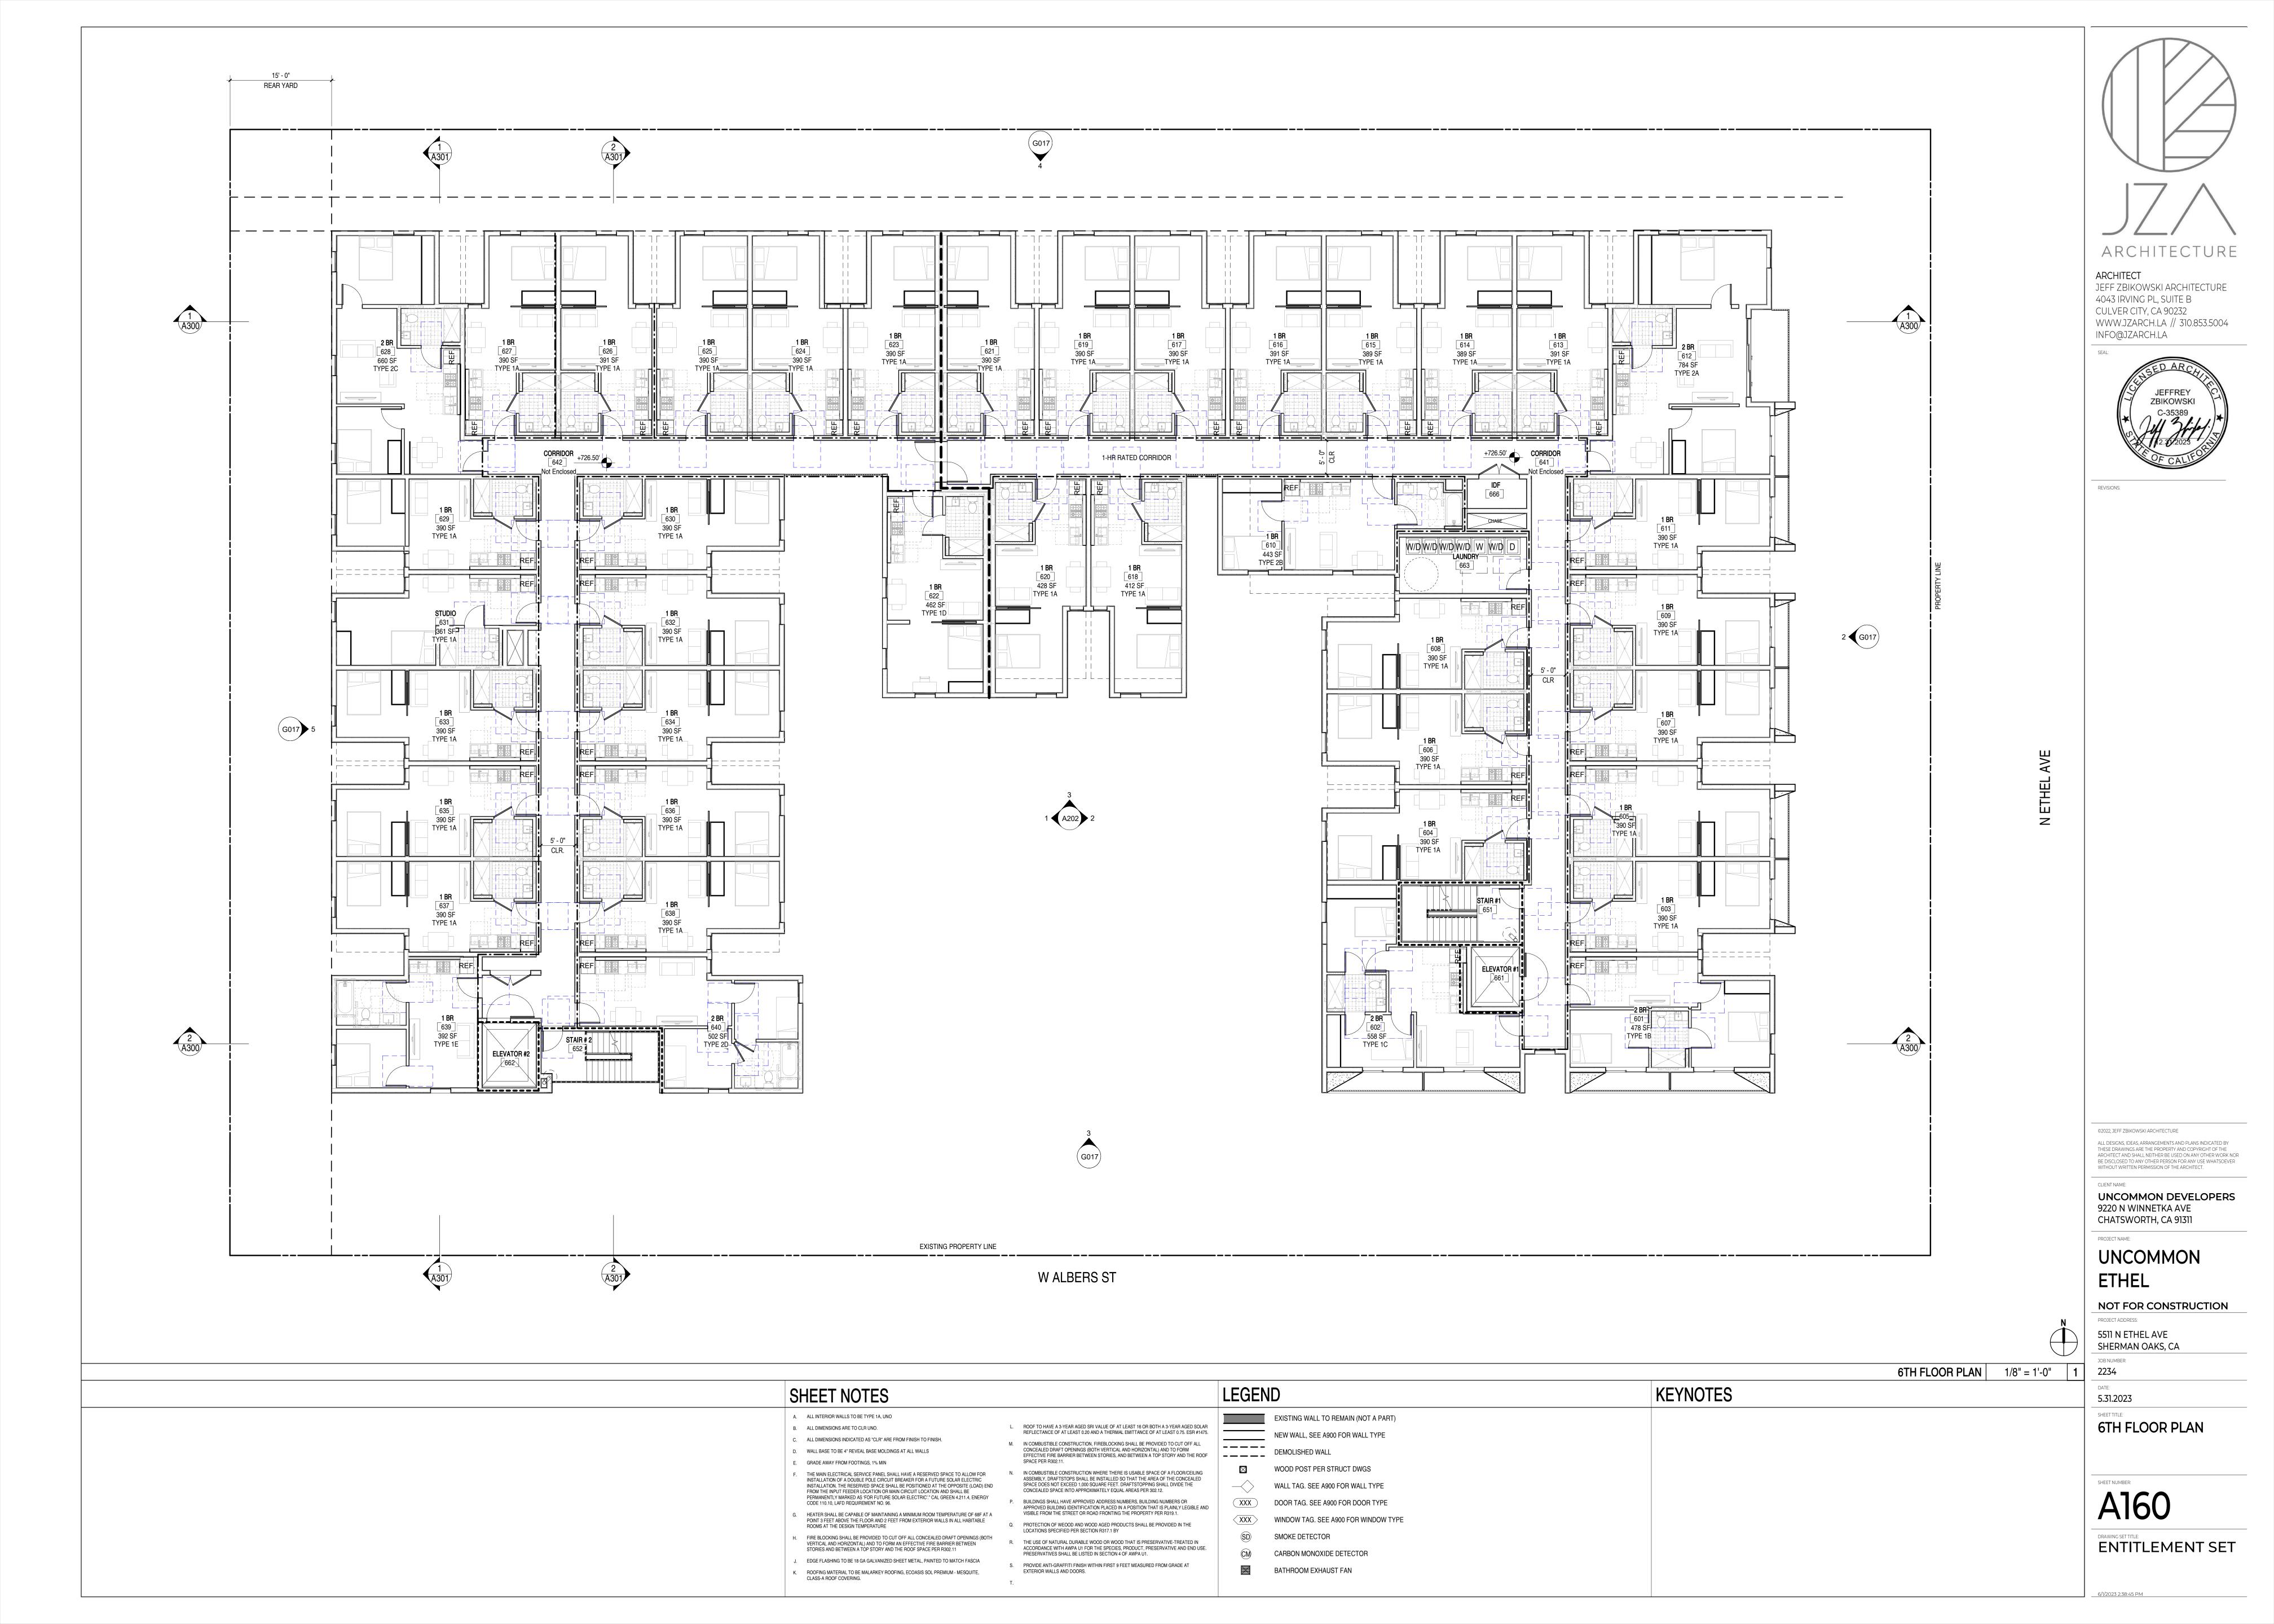




BATHROOM EXHAUST FAN

ROOFING MATERIAL TO BE MALARKEY ROOFING, ECOASIS SOL PREMIUM - MESQUITE,

EXTERIOR WALLS AND DOORS.


6/1/2023 2:38:49 PM

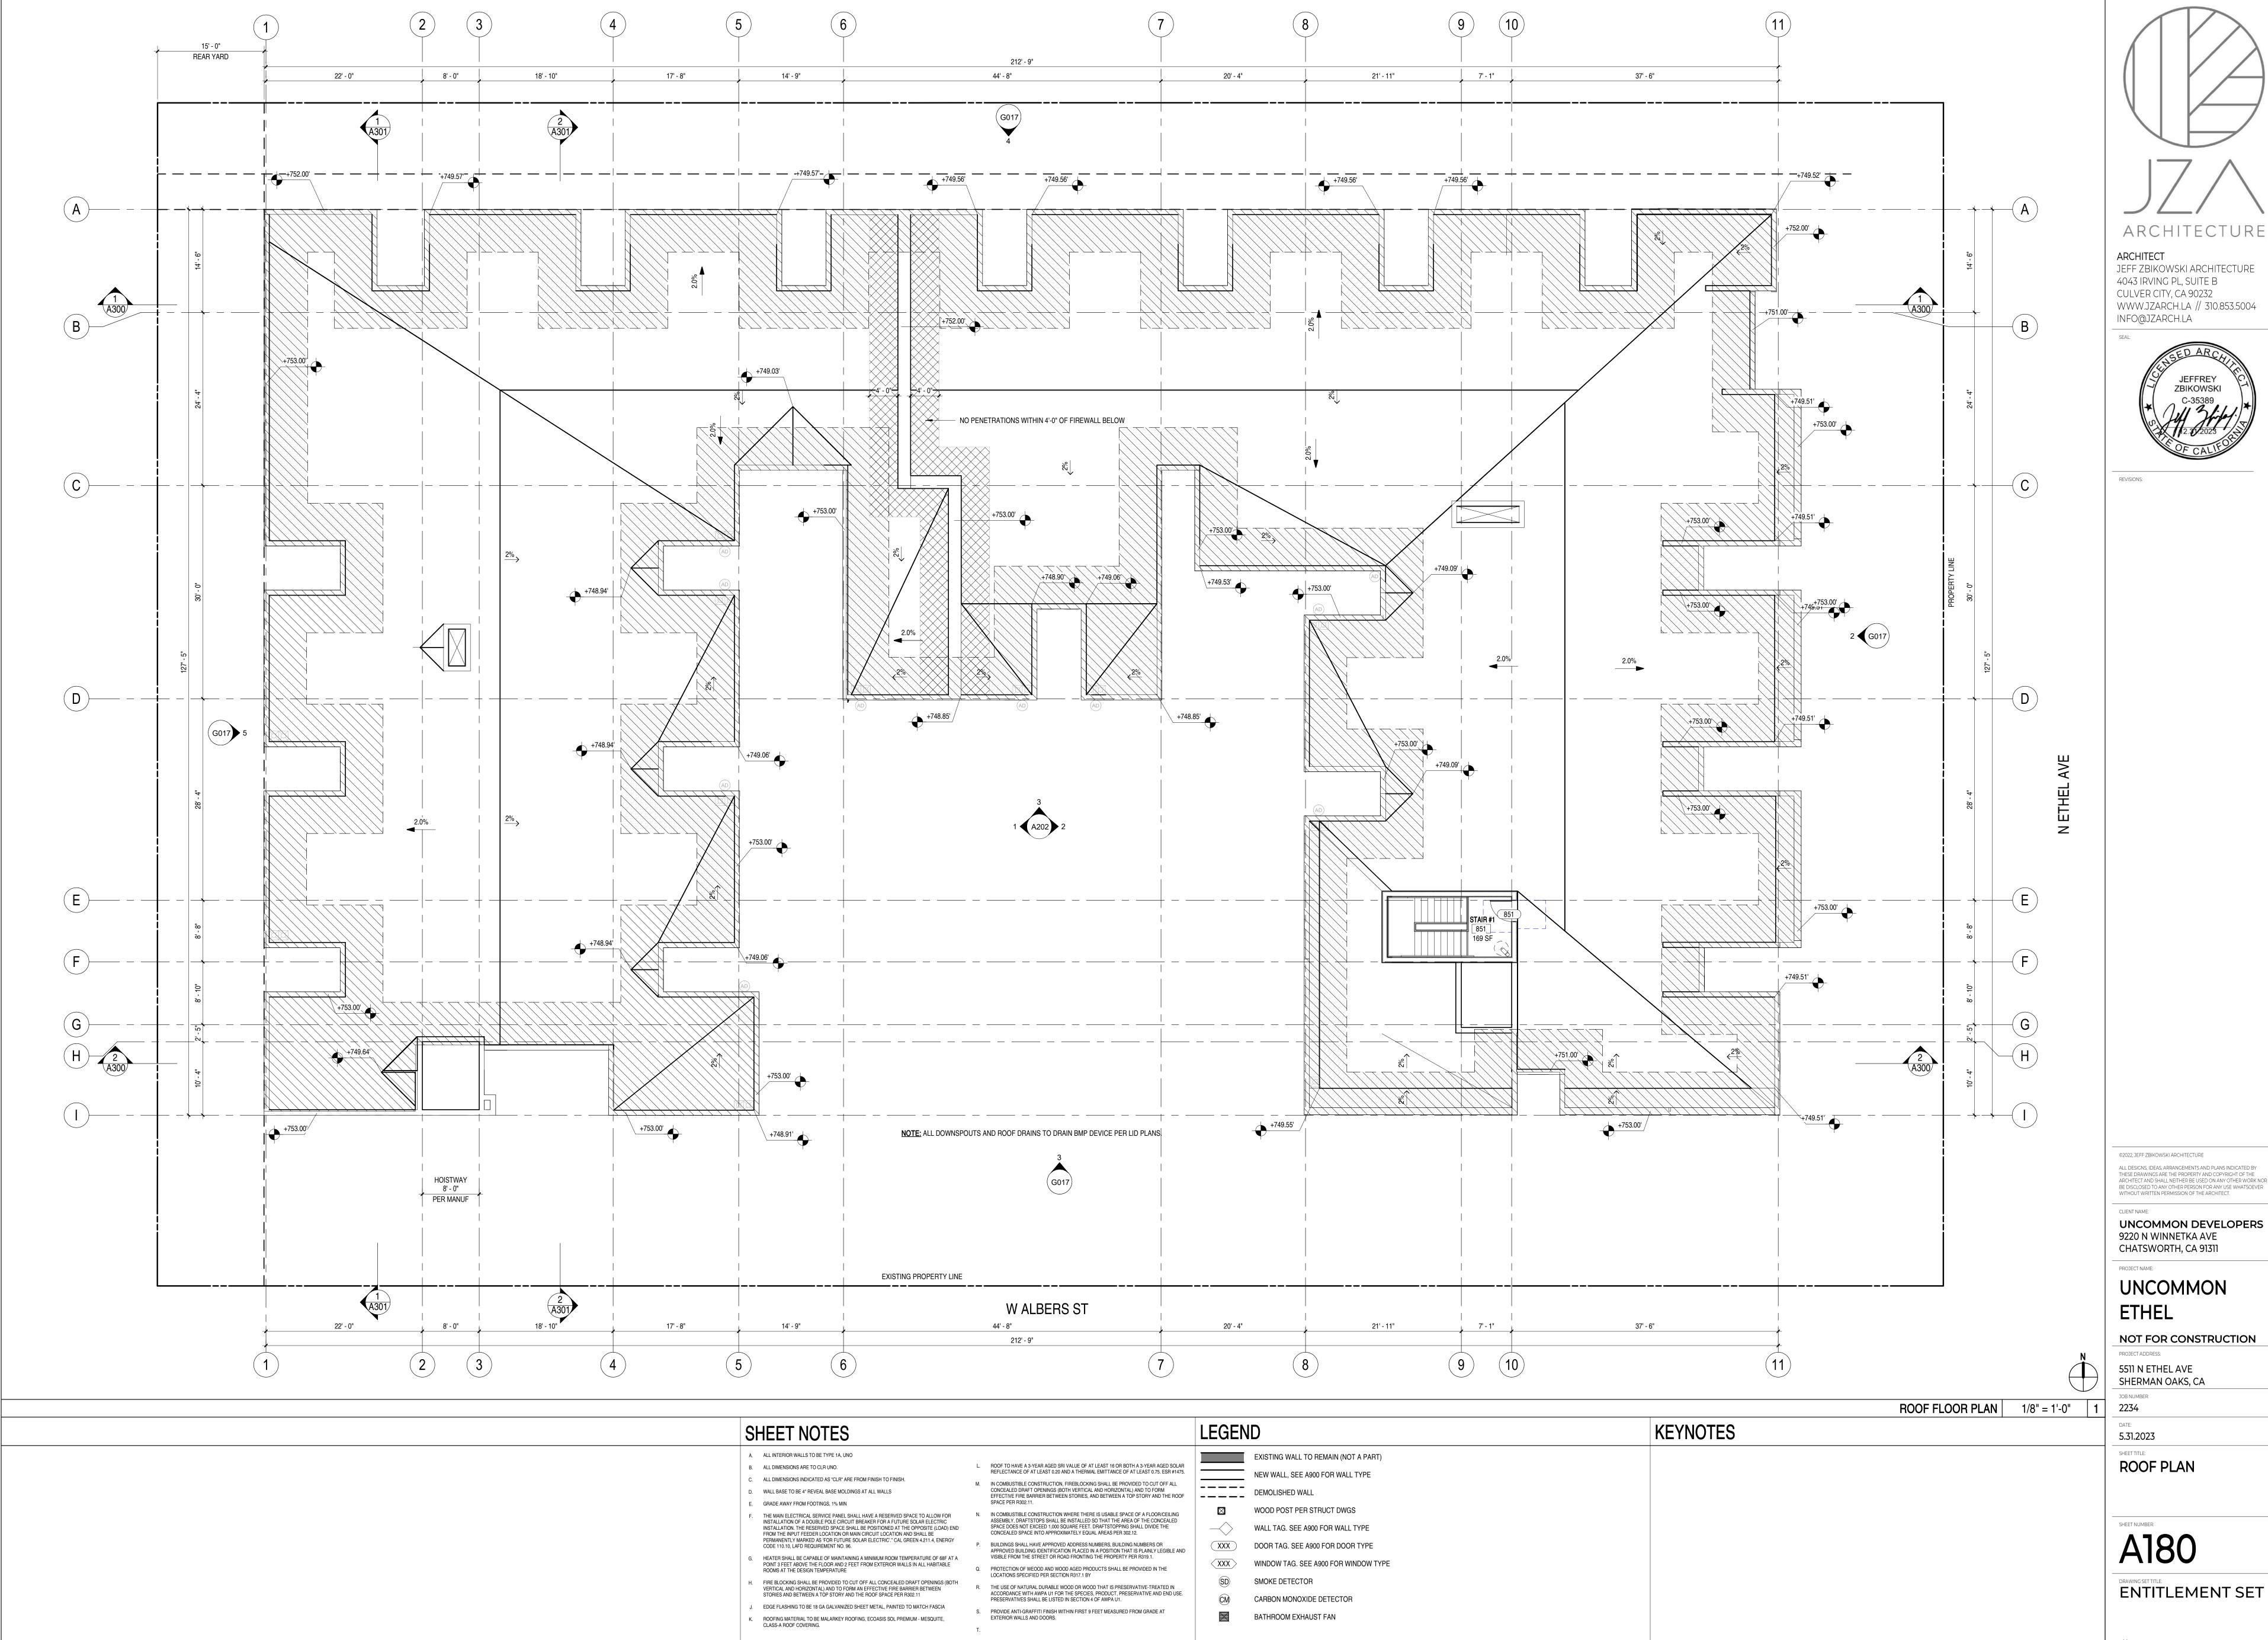



ARCHITECTURE



UNCOMMON DEVELOPERS

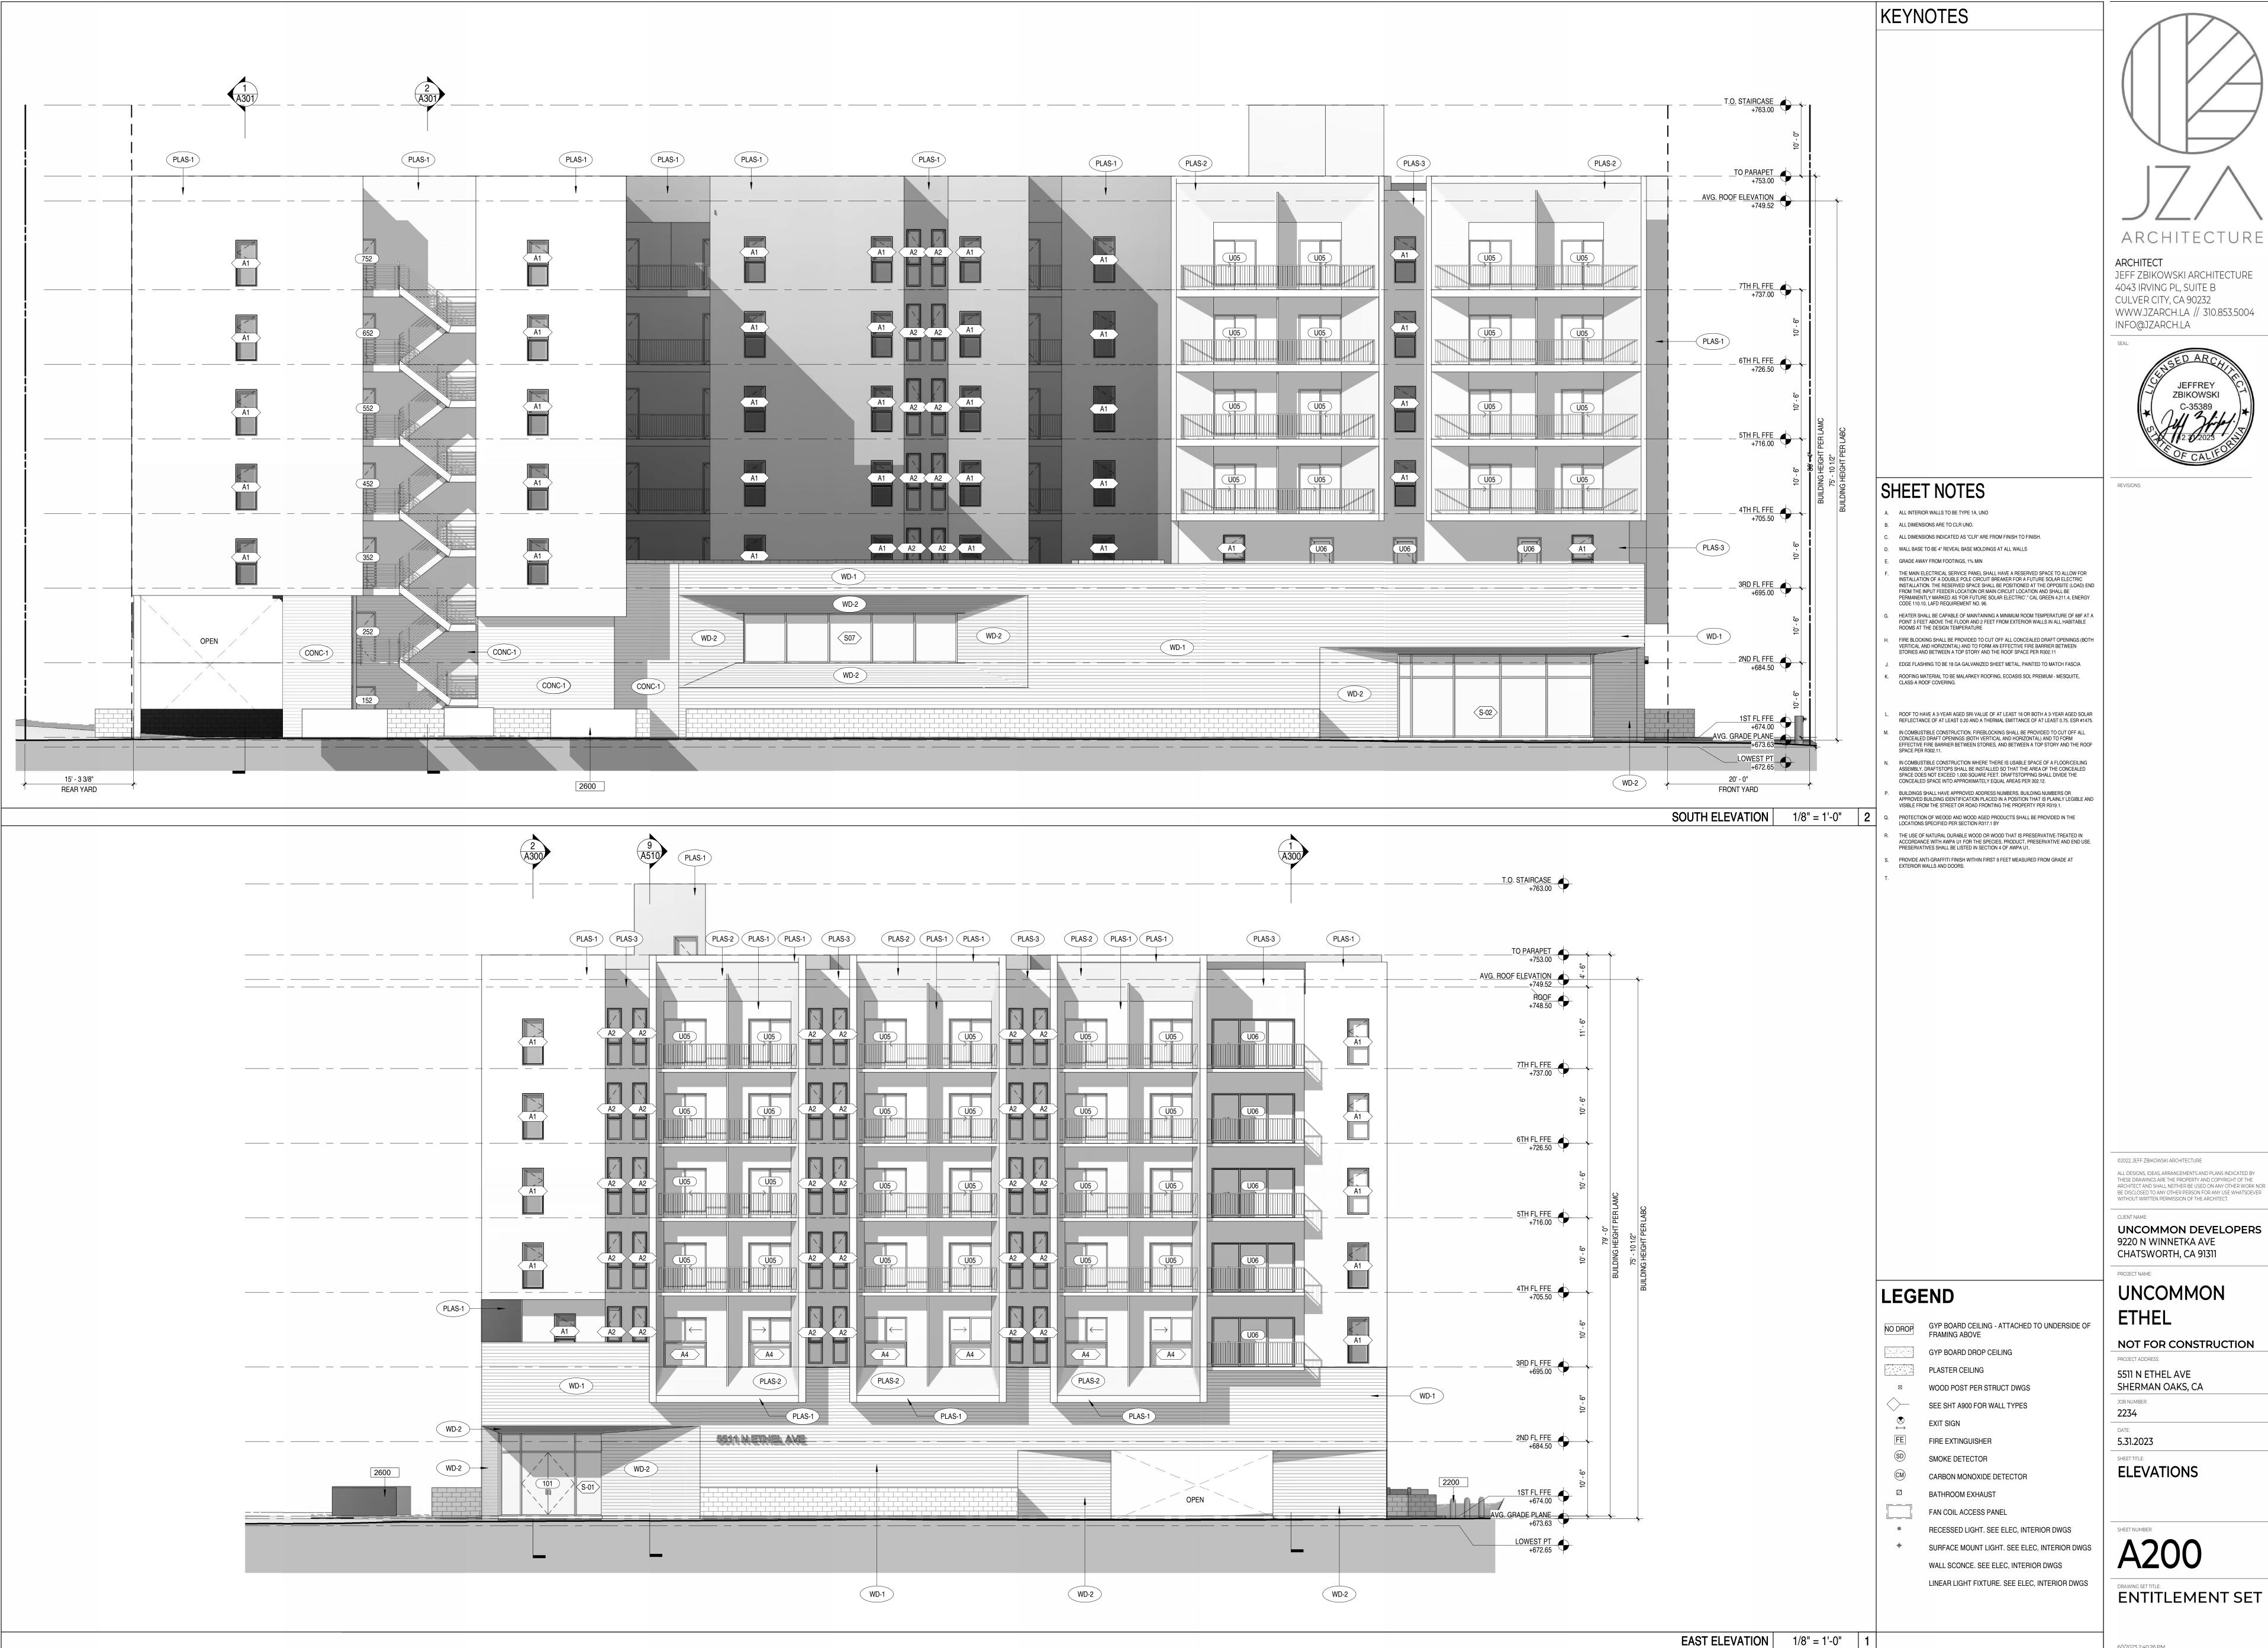

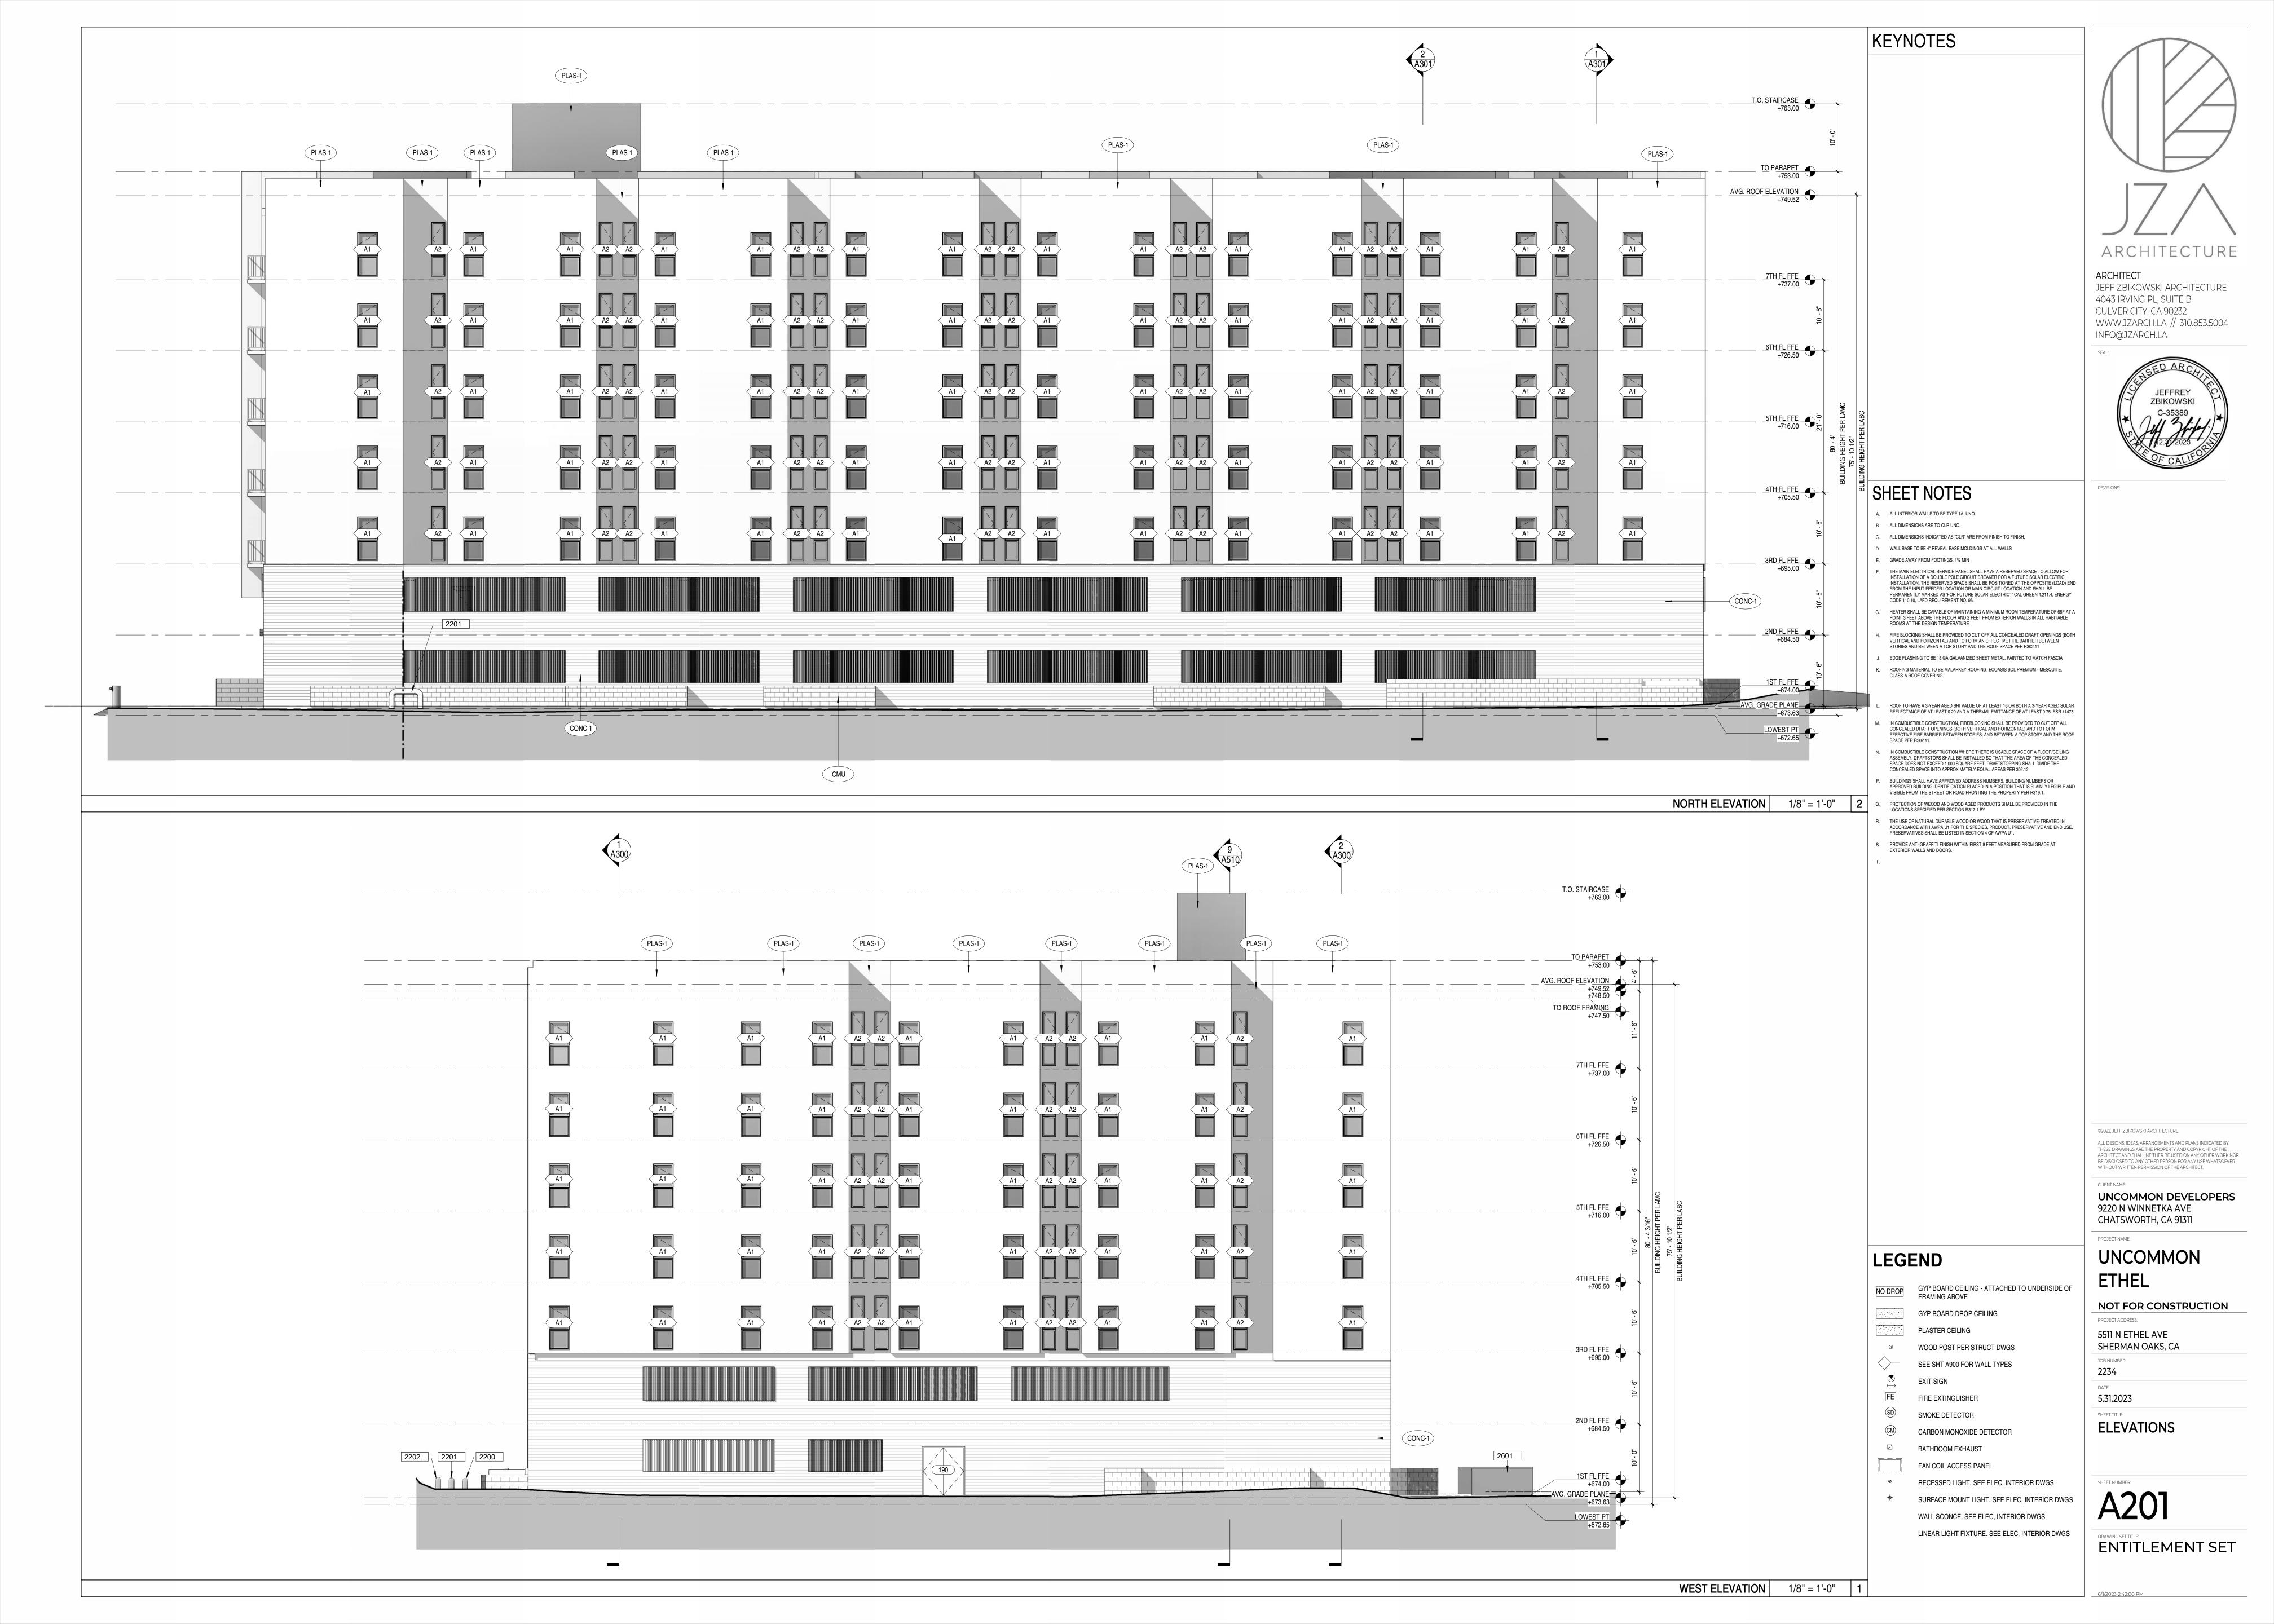

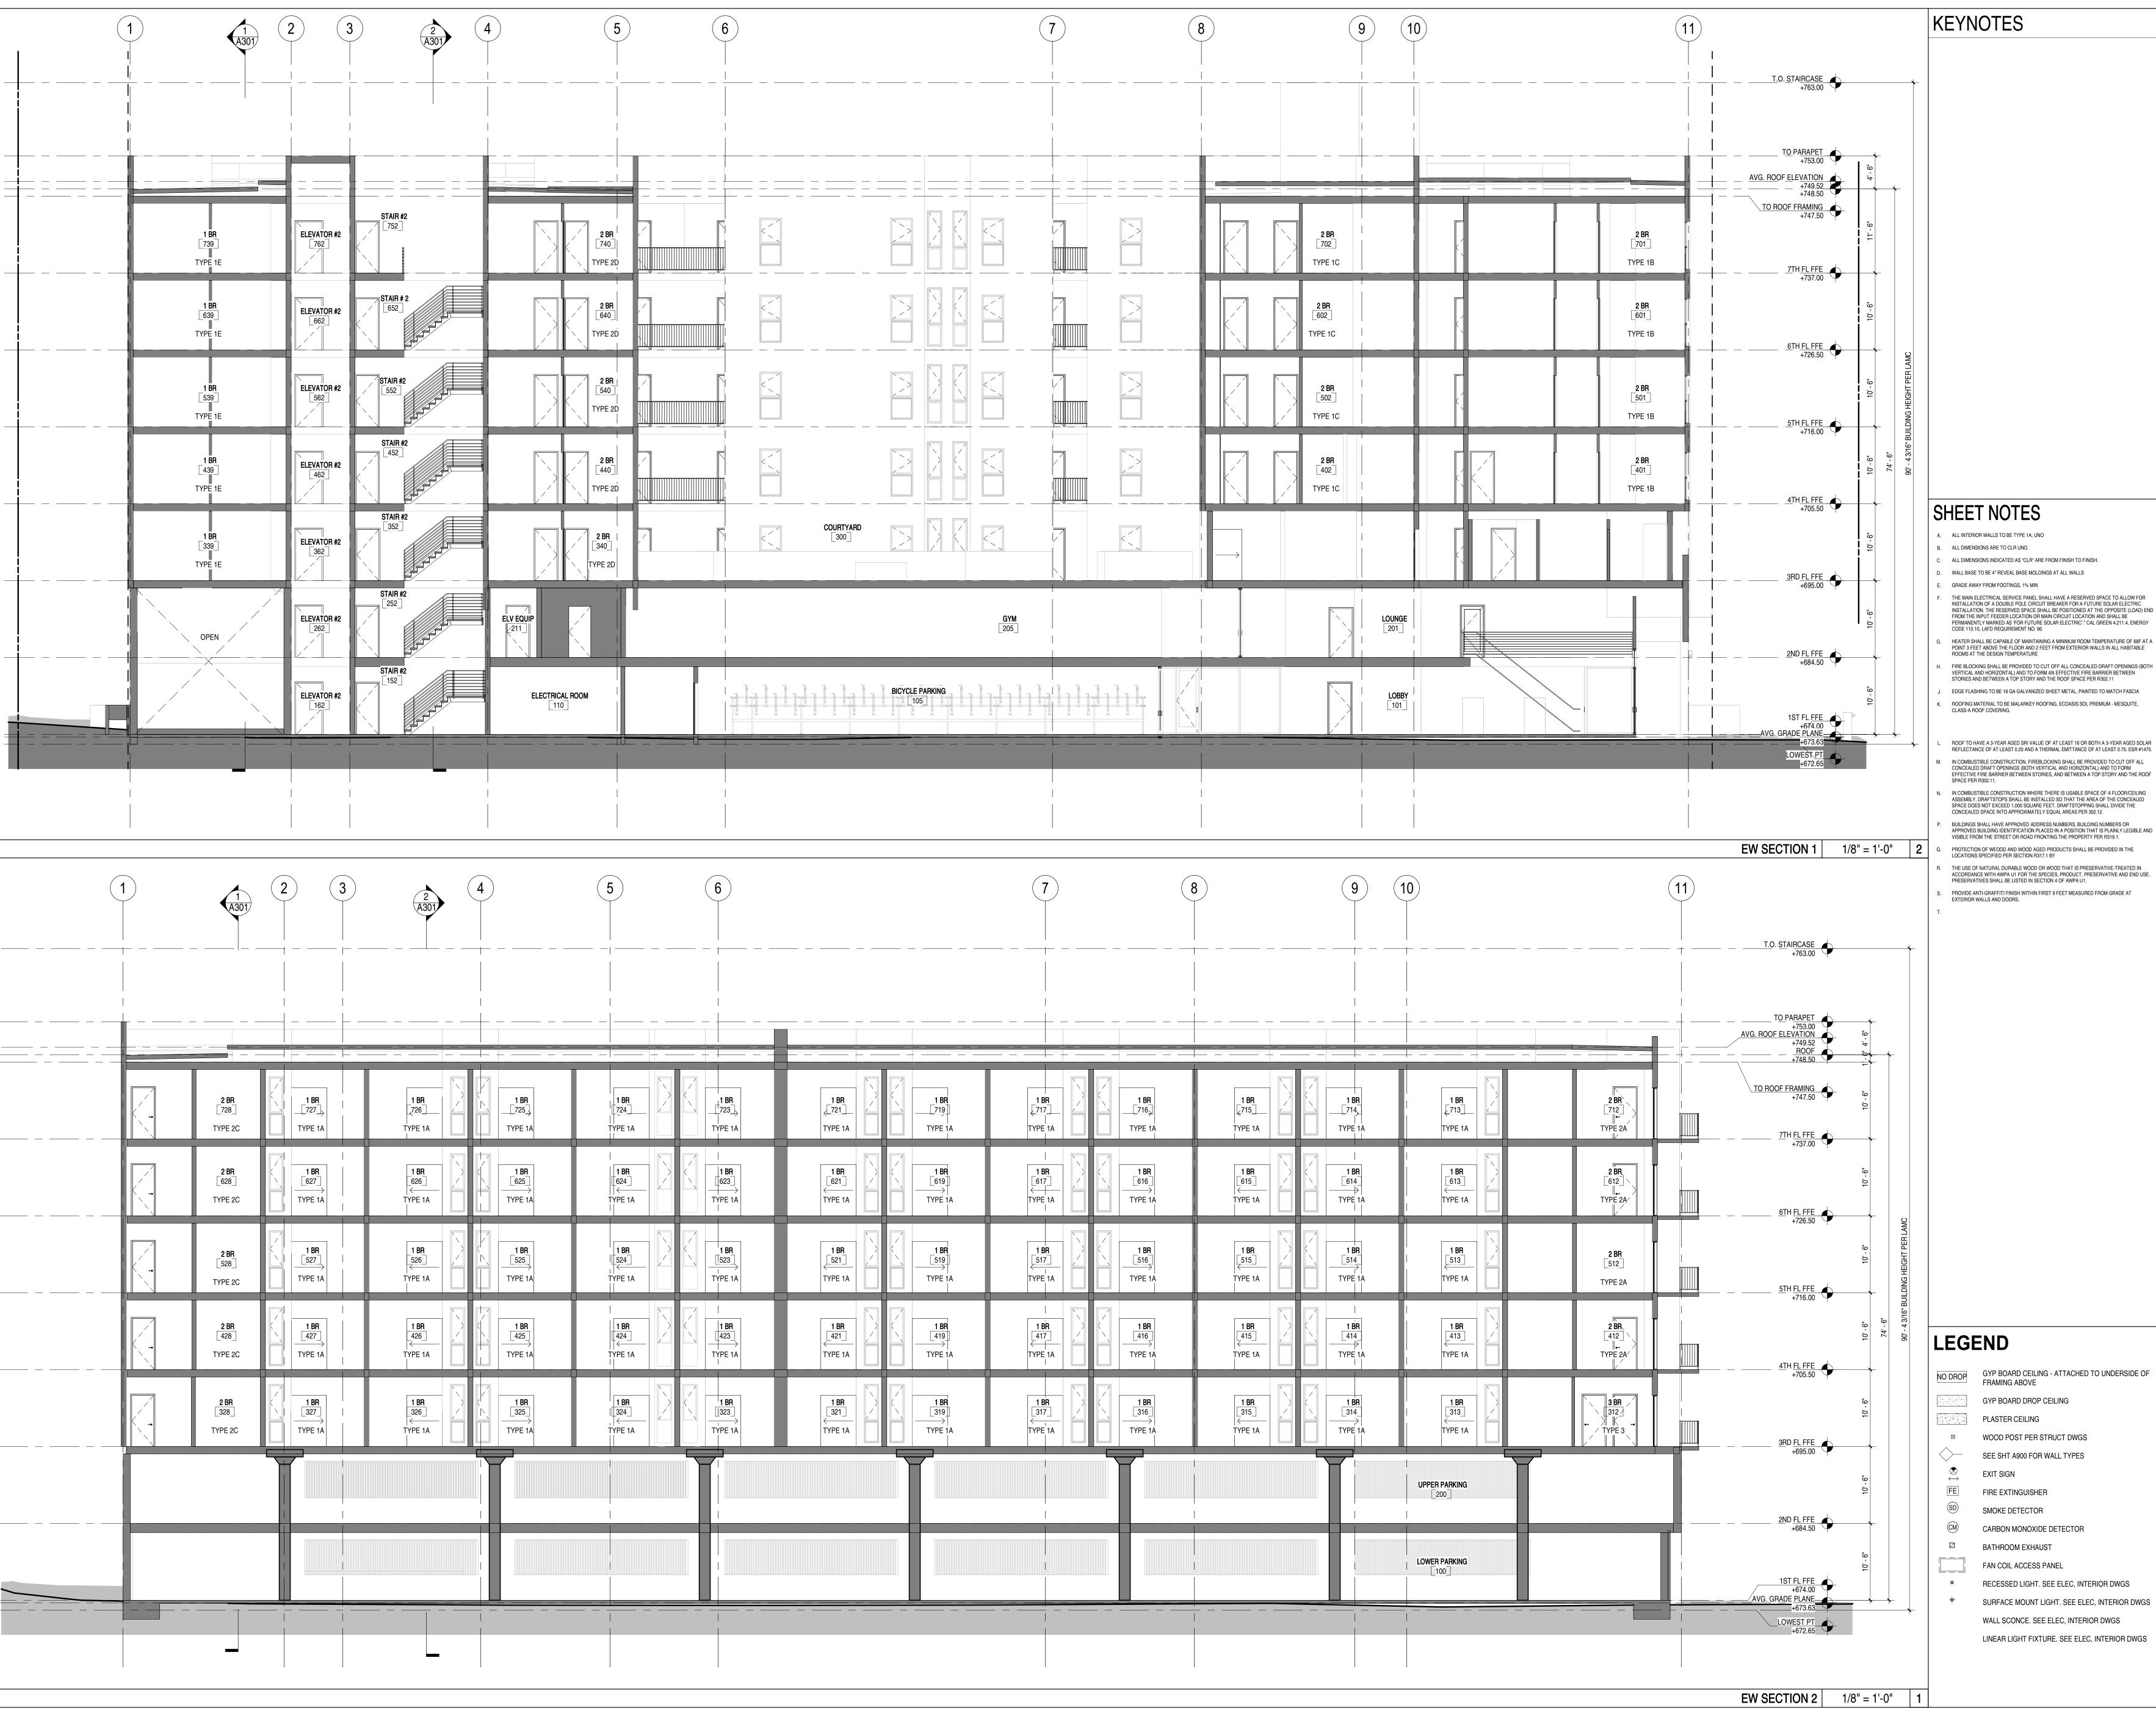



JEFF ZBIKOWSKI ARCHITECTURE 4043 IRVING PL, SUITE B CULVER CITY, CA 90232 WWW.JZARCH.LA // 310.853.5004 INFO@JZARCH.LA



REVISIONS:

- WALL BASE TO BE 4" REVEAL BASE MOLDINGS AT ALL WALLS
- INSTALLATION OF A DOUBLE POLE CIRCUIT BREAKER FOR A FUTURE SOLAR ELECTRIC INSTALLATION. THE RESERVED SPACE SHALL BE POSITIONED AT THE OPPOSITE (LOAD) END FROM THE INPUT FEEDER LOCATION OR MAIN CIRCUIT LOCATION AND SHALL BE PERMANENTLY MARKED AS 'FOR FUTURE SOLAR ELECTRIC'." CAL GREEN 4.211.4, ENERGY CODE 110.10, LAFD REQUIREMENT NO. 96.
- POINT 3 FEET ABOVE THE FLOOR AND 2 FEET FROM EXTERIOR WALLS IN ALL HABITABLE ROOMS AT THE DESIGN TEMPERATURE
- FIRE BLOCKING SHALL BE PROVIDED TO CUT OFF ALL CONCEALED DRAFT OPENINGS (BOTH VERTICAL AND HORIZONTAL) AND TO FORM AN EFFECTIVE FIRE BARRIER BETWEEN STORIES AND BETWEEN A TOP STORY AND THE ROOF SPACE PER R302.11
- ROOFING MATERIAL TO BE MALARKEY ROOFING, ECOASIS SOL PREMIUM MESQUITE,
- REFLECTANCE OF AT LEAST 0.20 AND A THERMAL EMITTANCE OF AT LEAST 0.75. ESR #1475. IN COMBUSTIBLE CONSTRUCTION, FIREBLOCKING SHALL BE PROVIDED TO CUT OFF ALL
- IN COMBUSTIBLE CONSTRUCTION WHERE THERE IS USABLE SPACE OF A FLOOR/CEILING ASSEMBLY, DRAFTSTOPS SHALL BE INSTALLED SO THAT THE AREA OF THE CONCEALED SPACE DOES NOT EXCEED 1,000 SQUARE FEET. DRAFTSTOPPING SHALL DIVIDE THE
- BUILDINGS SHALL HAVE APPROVED ADDRESS NUMBERS, BUILDING NUMBERS OR APPROVED BUILDING IDENTIFICATION PLACED IN A POSITION THAT IS PLAINLY LEGIBLE AND VISIBLE FROM THE STREET OR ROAD FRONTING THE PROPERTY PER R319.1.
- PROTECTION OF WEOOD AND WOOD AGED PRODUCTS SHALL BE PROVIDED IN THE LOCATIONS SPECIFIED PER SECTION R317.1 BY
- THE USE OF NATURAL DURABLE WOOD OR WOOD THAT IS PRESERVATIVE-TREATED IN ACCORDANCE WITH AWPA UT FOR THE SPECIES, PRODUCT, PRESERVATIVE AND END USE. PRESERVATIVES SHALL BE LISTED IN SECTION 4 OF AWPA U1.
- PROVIDE ANTI-GRAFFITI FINISH WITHIN FIRST 9 FEET MEASURED FROM GRADE AT

©2022, JEFF ZBIKOWSKI ARCHITECTURE ALL DESIGNS, IDEAS, ARRANGEMENTS AND PLANS INDICATED BY THESE DRAWINGS ARE THE PROPERTY AND COPYRIGHT OF THE ARCHITECT AND SHALL NEITHER BE USED ON ANY OTHER WORK NOR BE DISCLOSED TO ANY OTHER PERSON FOR ANY USE WHATSOEVER

WITHOUT WRITTEN PERMISSION OF THE ARCHITECT.

UNCOMMON DEVELOPERS 9220 N WINNETKA AVE CHATSWORTH, CA 91311

UNCOMMON

NOT FOR CONSTRUCTION

PROJECT ADDRESS: 5511 N ETHEL AVE SHERMAN OAKS, CA


RECESSED LIGHT. SEE ELEC, INTERIOR DWGS SURFACE MOUNT LIGHT. SEE ELEC, INTERIOR DWGS WALL SCONCE. SEE ELEC, INTERIOR DWGS

BUILDING SECTIONS

2234

5.31.2023

A300

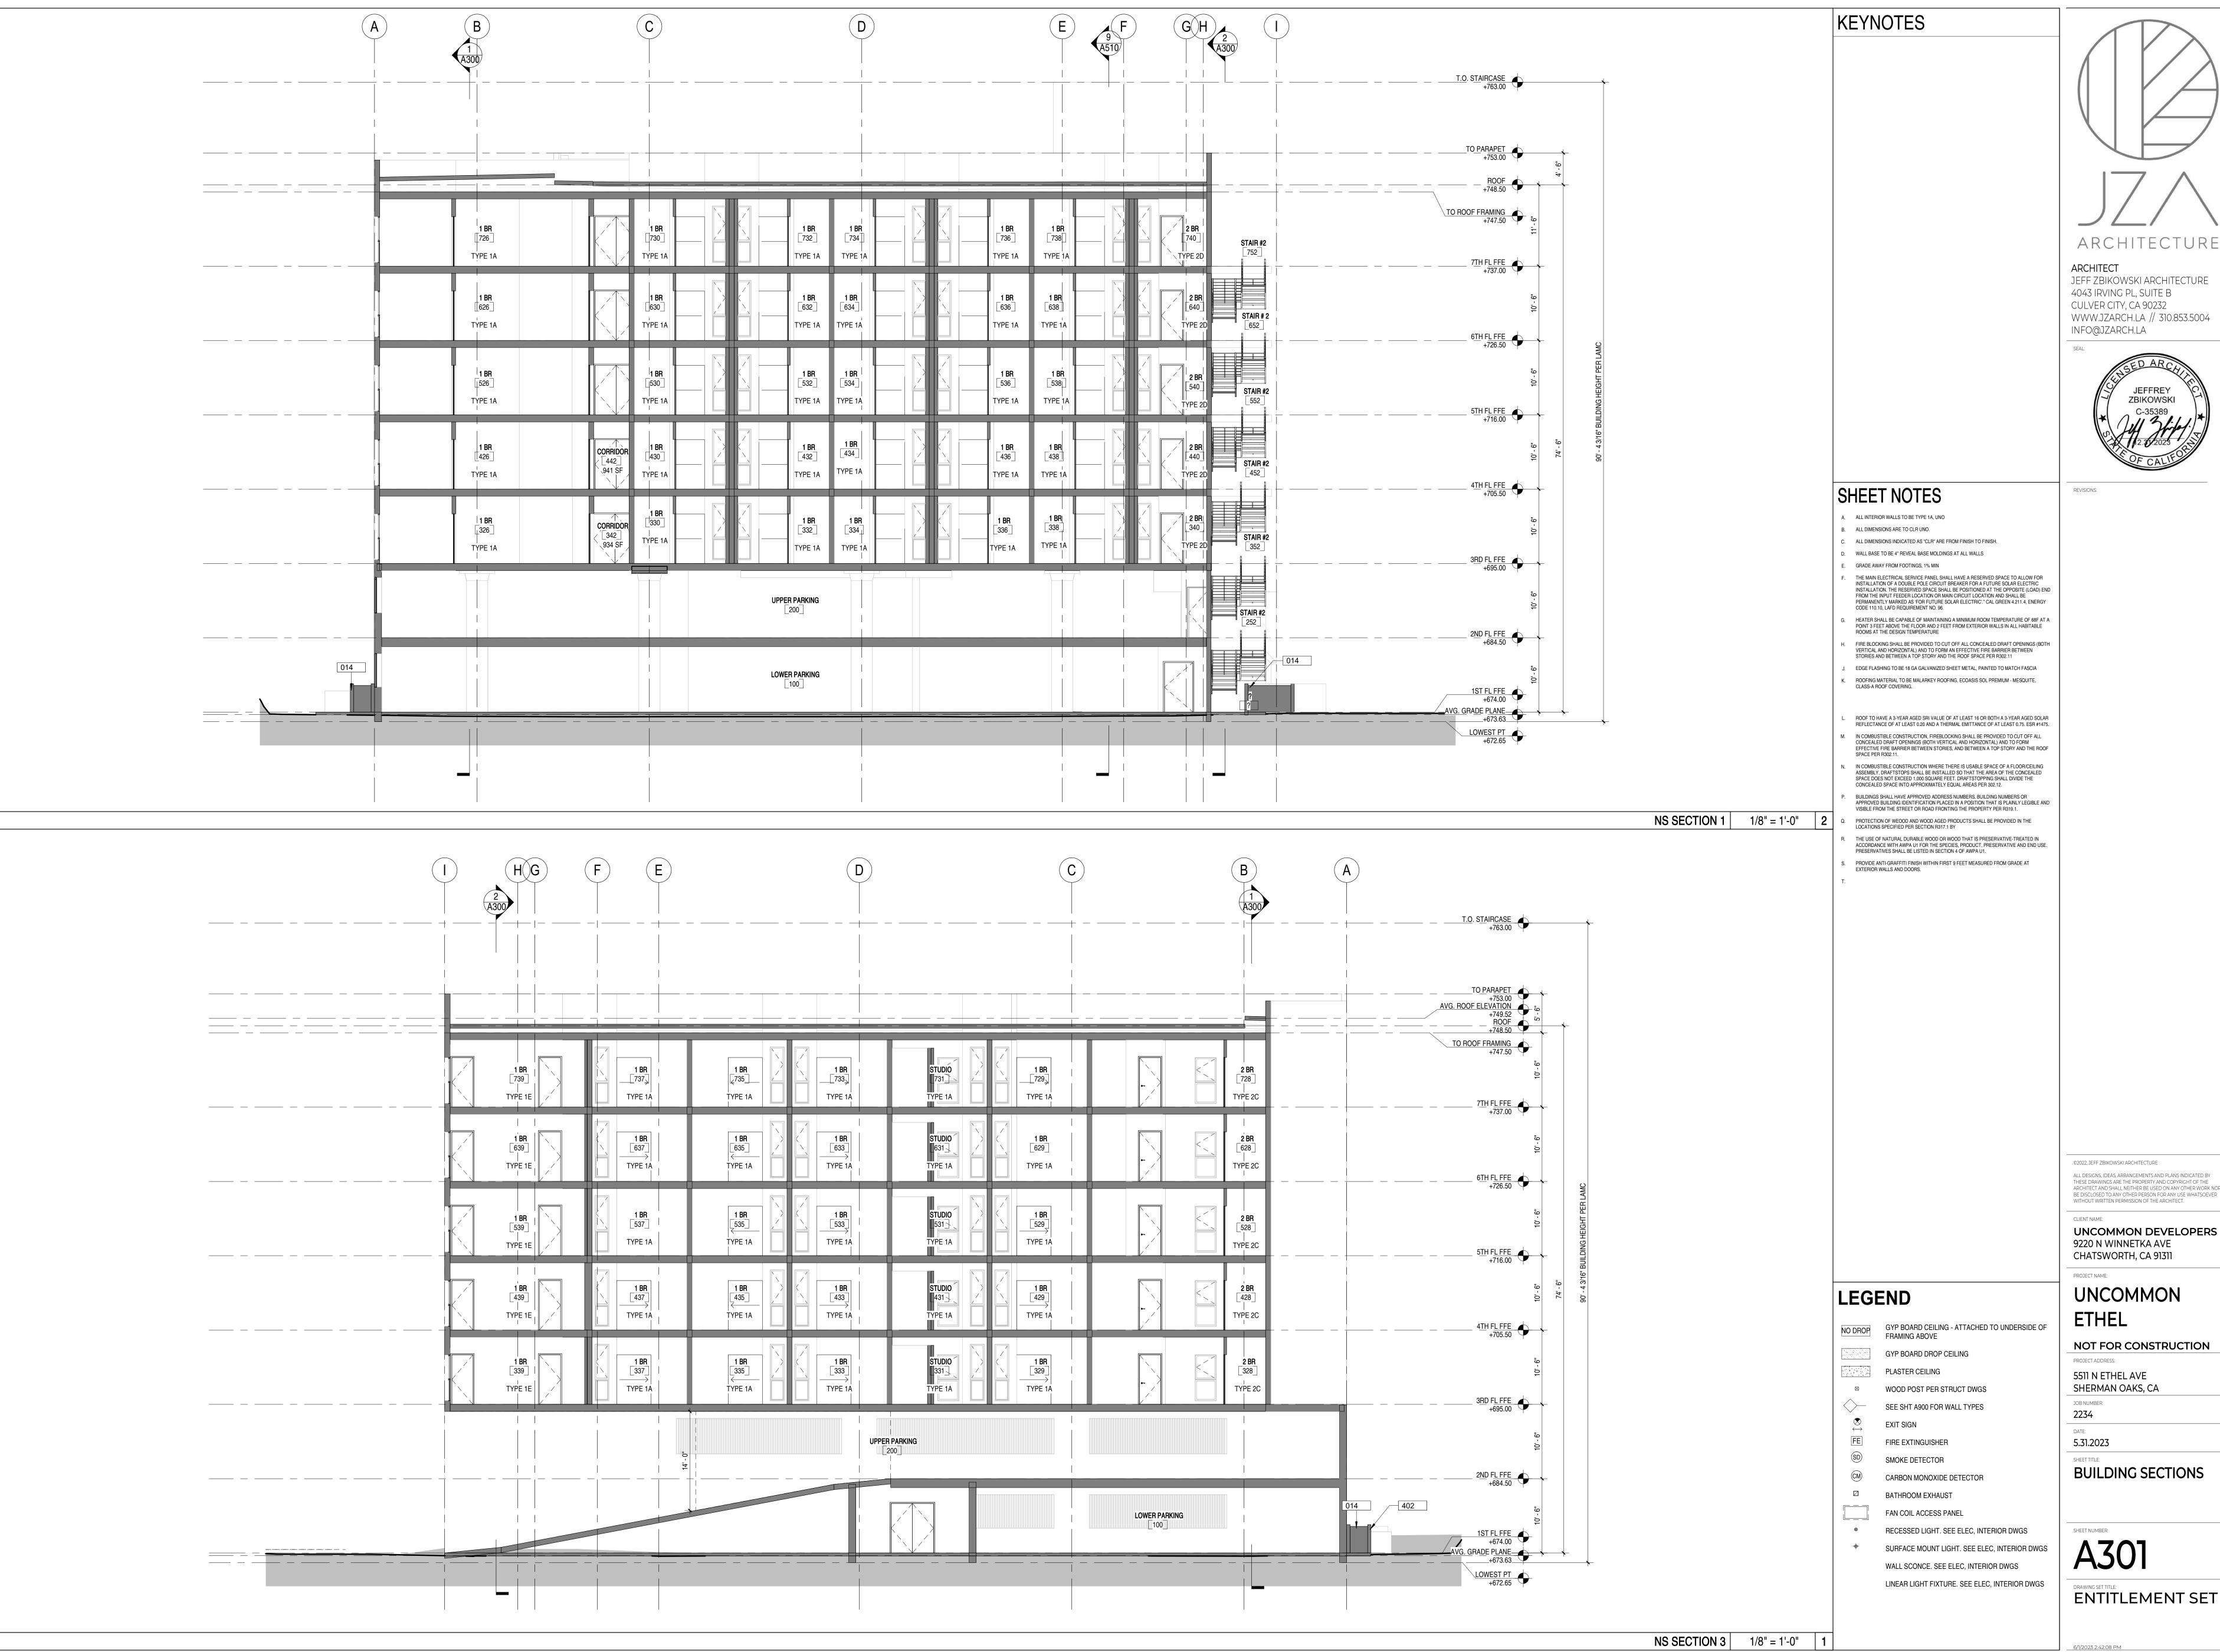

ARCHITECTURE

ARCHITECT JEFF ZBIKOWSKI ARCHITECTURE 4043 IRVING PL, SUITE B CULVER CITY, CA 90232 WWW.JZARCH.LA // 310.853.5004 INFO@JZARCH.LA



©2022, JEFF ZBIKOWSKI ARCHITECTURE ALL DESIGNS, IDEAS, ARRANGEMENTS AND PLANS INDICATED BY THESE DRAWINGS ARE THE PROPERTY AND COPYRIGHT OF THE ARCHITECT AND SHALL NEITHER BE USED ON ANY OTHER WORK NOR

UNCOMMON DEVELOPERS 9220 N WINNETKA AVE

CHATSWORTH, CA 91311 PROJECT NAME:

UNCOMMON

NOT FOR CONSTRUCTION PROJECT ADDRESS:

5511 N ETHEL AVE SHERMAN OAKS, CA


BUILDING SECTIONS

A301

DRAWING SET TITLE:

ENTITLEMENT SET

6/1/2023 2:42:08 PM

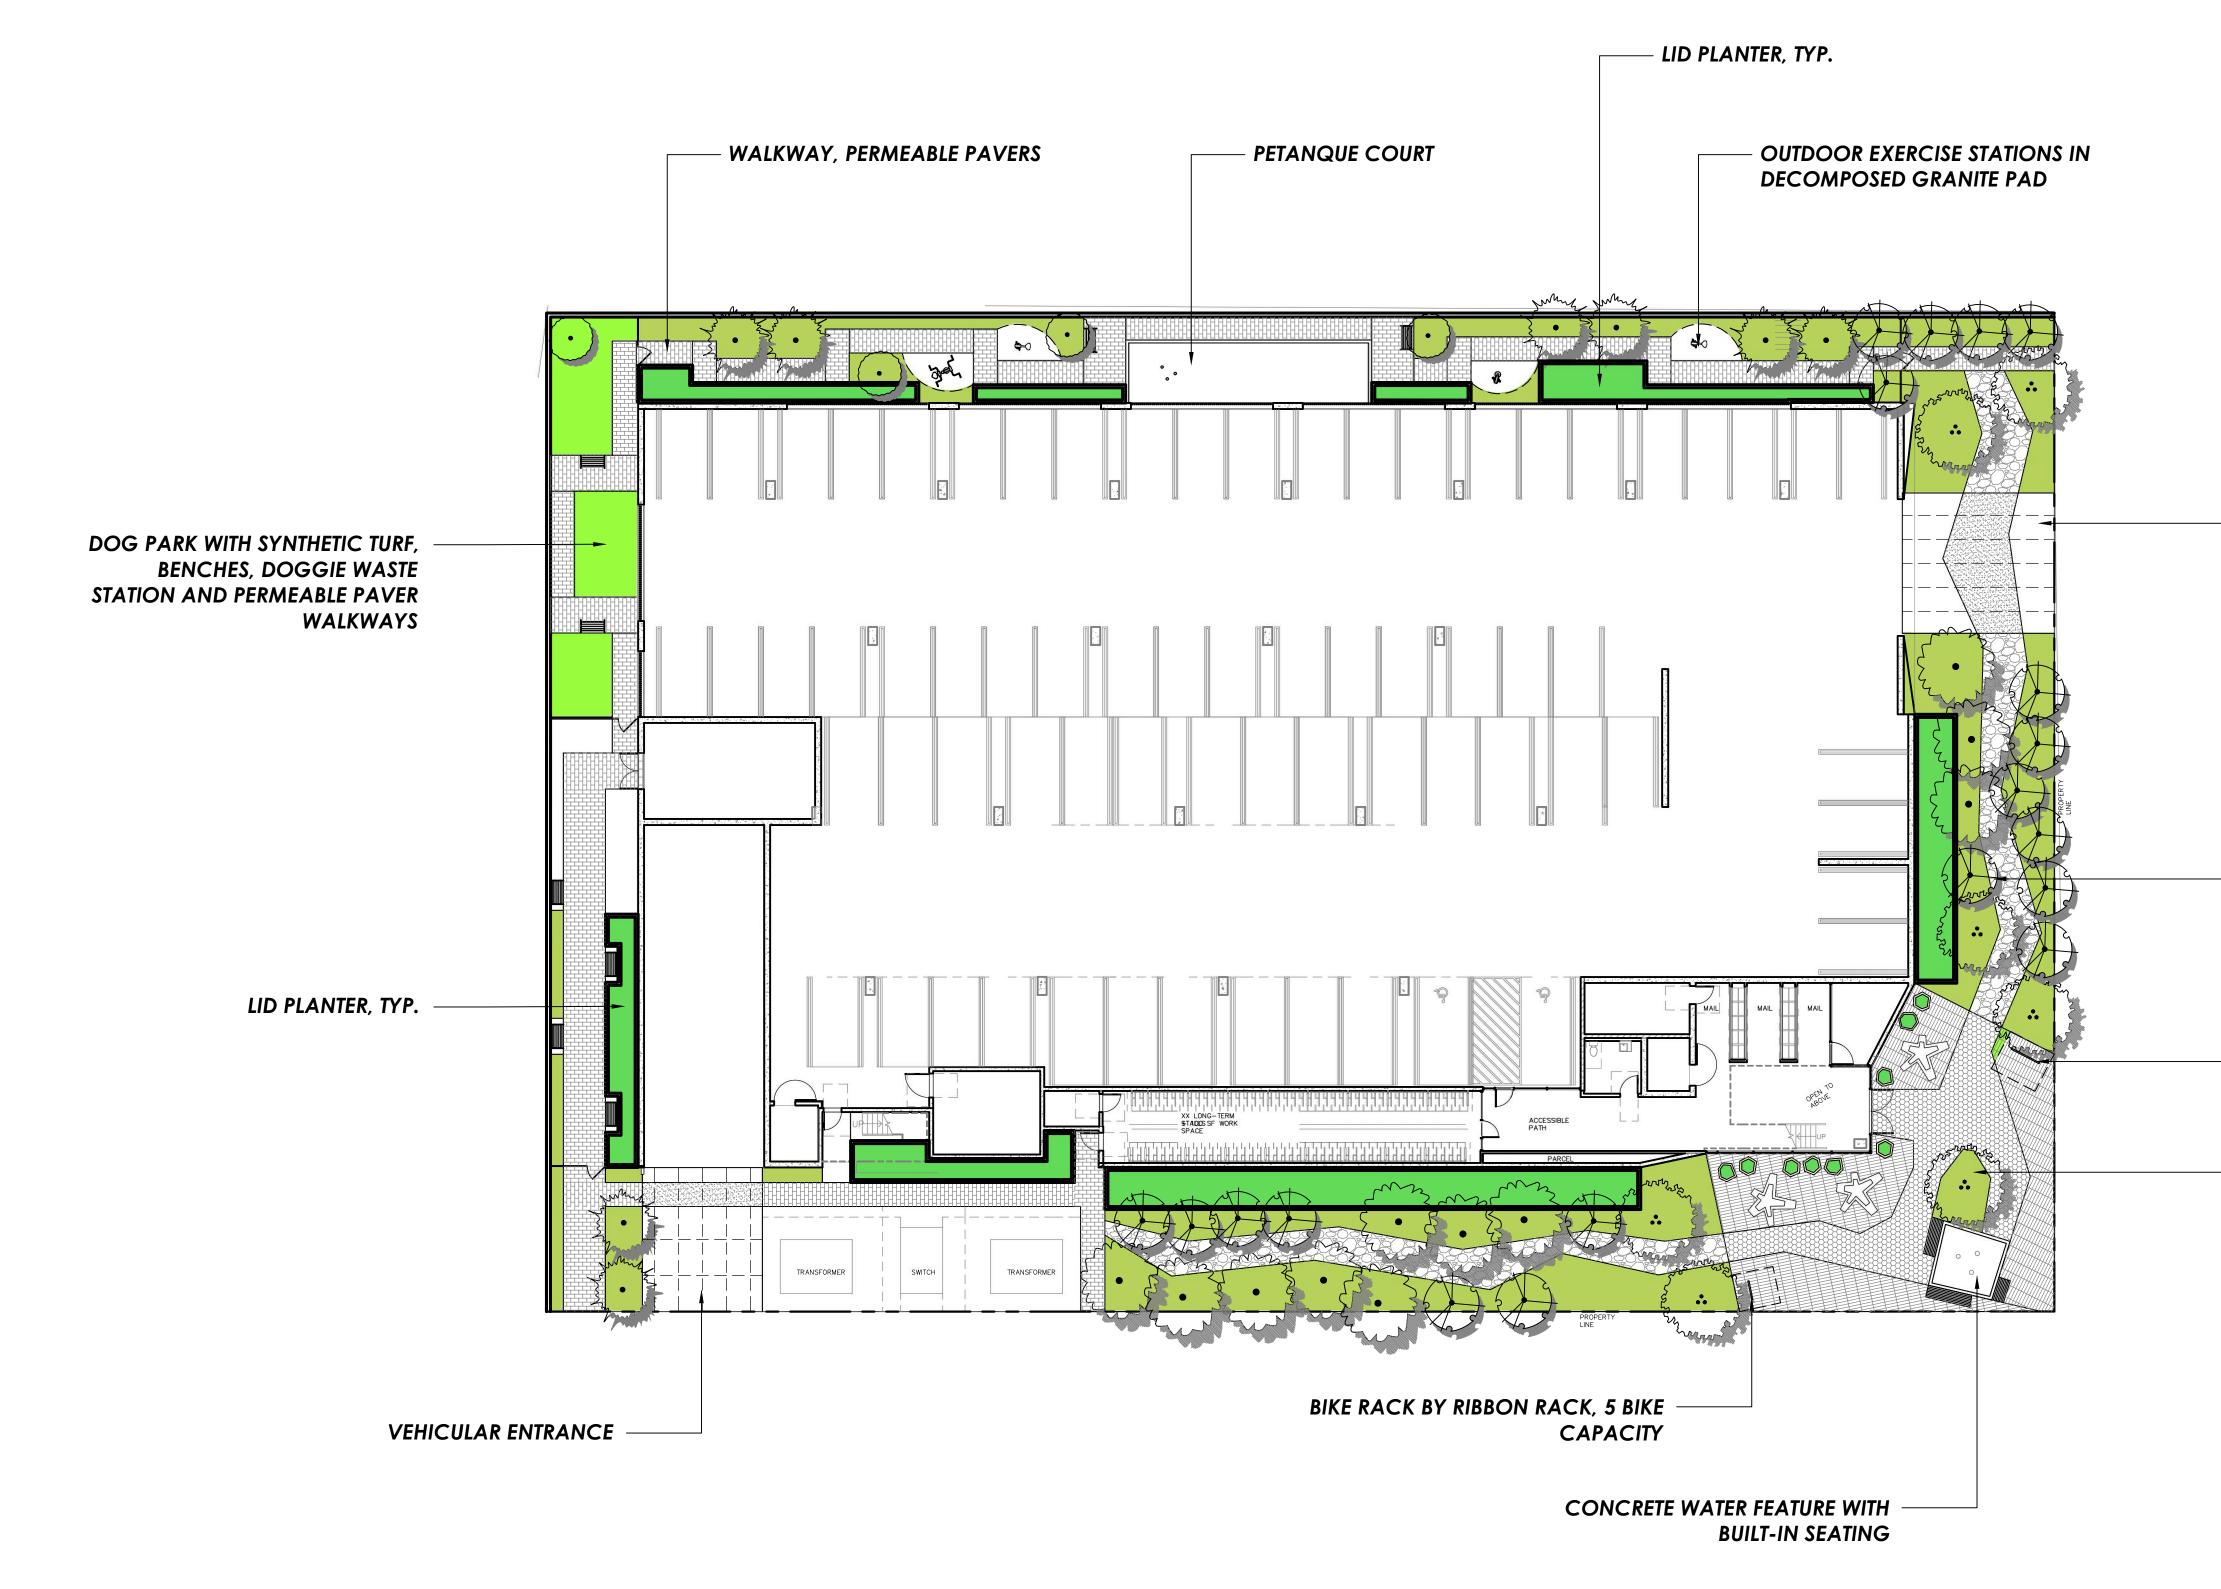

W. ALBERS ST

PLANT LEGEND -GROUND LEVEL BOTANICAL NAME SIZE/QT. WUCOLS SYMBOL "COMMON NAME" TREES - 24" BOX MIN. ACACIA ANEUA 24"BOX/2 | **LOW** "MULGA" ARBUTUS MARINA 24"BOX/8 LOW "STRAWBERRY TREE" CERCIDIUM 'DESERT MUSEUM' 24"BOX/18 | **VERY LOW** "DESERT MUSEUM PALO VERDE" CERCIS OCCIDENTALIS 24"BOX/4 LOW "WESTERN REDBUD" OLEA EUROPAEA 24"BOX/7 LOW "OLIVE" SHRUBS & GROUND COVERS BOTANICAL NAME SIZE WUCOLS "COMMON NAME" ANIGOZANTHOS SPECIES 5 GAL. MODERATE "KANGAROO PAW" ARISTIDA PURPUREA 5 GAL. VERY LOW "PURPLE THREE AWN" CALANDRINA GRANDIFLORA 5 GAL. LOW "ROCK PURSLANE" CISTUS SPECIES 5 GAL. LOW "ROCKROSE" DIETES SPECIES 5 GAL. "FORTNIGHT LILY" GREVILLEA NOELLI 5 GAL. "NOEL'S GREVILLEA" HESPERALOE SPECIES VERY LOW JUNIPERUS SPECIES 5 GAL. "JUNIPER" KALANCHOE BEHARENSIS 5 GAL. "ELEPHANT EARS LAVANDULA SPECIES 5 GAL. "LAVENDER" MUHLENBERGIA SPECIES 5 GAL. "MUHLY" PELARGONIUM SPECIES 5 GAL. "GERANIUM" PENNISETUM SPECIES 5 GAL. "FOUNTAIN GRASS" PHORMIUM SPECIES 5 GAL. "NEW ZEALAND FLAX" SALVIA SPECIES 5 GAL. "SAGE" SEDUM SPECIES 5 GAL. "STONE CROP" SENECIO SPECIES 5 GAL. "CHALKSTICKS" WESTRINGIA SPECIES 5 GAL. "COAST ROSEMARY"

GENERAL NOTES:

- 'DRY CREEK' WITH LARGE DECORATIVE RIVER

BIKE RACK BY RIBBON RACK, 7 BIKE

- ENTRY PLAZA WITH PERMEABLE PAVERS,

SCULPTURAL CONCRETE PLANTERS AND

VEHICULAR ENTRANCE

ROCK

CAPACITY

SEATING

- 1. ALL LANDSCAPE AREAS WILL BE IRRIGATED W/ A HIGH EFFICIENCY IRRIGATION W/ SMART IRRIGATION CONTROLS.
- 2. ALL PLANTING & IRRIGATION SHALL COMPLY WITH CITY OF LOS ANGELES REQUIREMENTS. 3. IRRIGATION DESIGN WILL INCORPORATE EPA WATERSENSE
- **SPECIFICATIONS** STREET TREES SHALL BE SELECTED AND INSTALLED PER CITY OF LOS ANGELES DEPARTMENT OF URBAN FORESTRY.
 ALL NEW PLANTED AREAS TO BE HEAVILY MULCHED FOR WATER
- CONSERVATION.
- 6. THERE ARE NO SIGNIFICANT TREES TO BE REMOVED ON THE SITE.
 7. THERE ARE NO PROTECTED TREES ON THE SITE.

WATER CONSERVATION STATEMENT:


ALL LANDSCAPE WILL BE SPECIFIED, PLANTED & IRRIGATED ACCORDING TO XERISCAPE DESIGN PRINIPLES WHICH INCLUDE: THE PREDOMINANT USE OF DROUGHT TOLERANT PLANT MATERIALS; THE PRACTICE OF HYDROZONING OR GROUPING PLANTS WITH SIMILAR WATER REQUIREMENTS TOGETHER; MINIMIZING TURF AREAS AND THE EFFICIENT APPLICATION OF WATER BY USING MATCH PRECIPITATION HEADS, DRIP LINE, SEPARATE VALVES FOR TURF AND GROUND COVER AREAS AND RAIN SHUT OFF DEVICES. THIS PROJECT WILL COMPLY WITH THE STATE WATER CONSERVATION ORDINANCE EFFECTIVE JANUARY 1, 2010.

LANDSCAPE AREA	
LEVEL 1	
PLANTERS	= 3,709 S.F.
LID PLANTERS	= 1,333 S.F.
DRY CREEK	= 1,115 S.F.
LEVEL 3	
PLANTERS	= 710 S.F.
LID PLANTERS	= 481 S.F.
TOTAL LANDSCAPE AREA PROVIDED	= 7,466 S.F.

OUTDOOR COMMON OPEN SPACE	
OUTDOOR COMMON OPEN SPACE PROVIDED LEVEL 1	= 7,280 S.F.
MINIMUM (25%) REQUIRED LANDSCAPE AREA LEVEL 1	= 1,820 S.F.
LANDSCAPE AREA PROVIDED LEVEL 1	= 3,417 S.F.
OUTDOOR COMMON OPEN SPACE PROVIDED LEVEL 3	= 4,770 S.F.
MINIMUM (25%) REQUIRED LANDSCAPE AREA LEVEL 3	= 1,194 S.F.
LANDSCAPE AREA PROVIDED LEVEL 3	= 1,240 S.F.

	TREE COUNT SUMMARY	
	TOTAL NO. OF UNITS	= 200
	NO. OF TREES (24" BOX MIN.) REQUIRED 1 PER 4 UNITS	= 50
	NO. OF TREES (24" BOX MIN.) PLANTED: LEVEL 1 LEVEL 3	= 49 = 14
	TOTAL PROVIDED	= 63

SCALE: 1/16" = 1'-0"

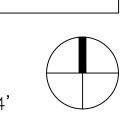


ARCHITECT JEFF ZBIKOWSKI ARCHITECTURE 4043 IRVING PL, SUITE B CULVER CITY, CA 90232 WWW.JZARCH.LA // 310.853.5004 INFO@JZARCH.LA

REVISIONS:

Site Planning Urban Desiç

Landscape Architectur

PO Box 704 Montrose CA 910: Tel 818 797 5914 Web www.tgpinc.n

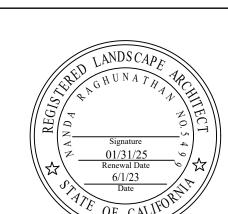

©2022, JEFF ZBIKOWSKI ARCHITECTURE ALL DESIGNS, IDEAS, ARRANGEMENTS AND PLANS INDICATED BY THESE DRAWINGS ARE THE PROPERTY AND COPYRIGHT OF THE ARCHITECT AND SHALL NEITHER BE USED ON ANY OTHER WORK NOR BE DISCLOSED TO ANY OTHER PERSON FOR ANY USE WHATSOEVER WITHOUT WRITTEN PERMISSION OF THE ARCHITECT. CLIENT NAME: UNCOMMON DEVELOPERS

CHATSWORTH, CA 91311 PROJECT NAME:

9220 N WINNETKA AVE

ETHEL NOT FOR CONSTRUCTION PROJECT ADDRESS:

5511 N ETHEL AVE SHERMAN OAKS, CA

5.31.2023


SHEET TITLE:
GROUND LEVEL



PLANT LEGEND -LEVEL 3 BOTANICAL NAME WUCOLS SIZE/QT. SYMBOL RATING "COMMON NAME" TREES - 24" BOX MIN. FEIJOA SELLOWIANA 24"BOX/2 "PINEAPPLE GUAVA" OLEA EUROPAEA 24"BOX/4 PRUNUS ILICIFOLIA LYONII 24"BOX/4 "CATALINA CHERRY" SHRUBS & GROUND COVERS **BOTANICAL NAME** SIZE WUCOLS "COMMON NAME" ANIGOZANTHOS SPECIES 5 GAL. MODERATE "KANGAROO PAW" ARISTIDA PURPUREA 5 GAL. VERY LOW "PURPLE THREE AWN" CALANDRINA GRANDIFLORA 5 GAL. "ROCK PURSLANE" CISTUS SPECIES 5 GAL. "ROCKROSE" DIETES SPECIES 5 GAL. "FORTNIGHT LILY" GREVILLEA NOELLI 5 GAL. LOW "NOEL'S GREVILLEA" HESPERALOE SPECIES 5 GAL. VERY LOW "YUCCA" JUNIPERUS SPECIES 5 GAL. "JUNIPER" KALANCHOE BEHARENSIS 5 GAL. "ELEPHANT EARS LAVANDULA SPECIES "LAVENDER" MUHLENBERGIA SPECIES 5 GAL. "MUHLY" PELARGONIUM SPECIES 5 GAL. "GERANIUM" PENNISETUM SPECIES 5 GAL. "FOUNTAIN GRASS" PHORMIUM SPECIES 5 GAL. "NEW ZEALAND FLAX" SALVIA SPECIES 5 GAL. "SAGE" SEDUM SPECIES 5 GAL. LOW "STONE CROP" SENECIO SPECIES 5 GAL. "CHALKSTICKS" WESTRINGIA SPECIES 5 GAL. LOW "COAST ROSEMARY"

COMMUNAL DINING AREA WITH BAR/BBQ COUNTER, ENHANCED PAVING AND METAL TRELLIS ABOVE.

W. ALBERS ST

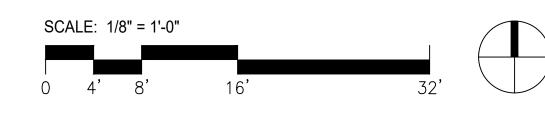


ARCHITECT JEFF ZBIKOWSKI ARCHITECTURE 4043 IRVING PL, SUITE B CULVER CITY, CA 90232 WWW.JZARCH.LA // 310.853.5004 INFO@JZARCH.LA

REVISIONS:



Landscape Architectur Site Planning Urban Desiç

PO Box 704 Montrose CA 910: Tel 818 797 5914 Web www.tgpinc.n

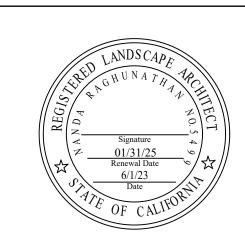

©2022, JEFF ZBIKOWSKI ARCHITECTURE ALL DESIGNS, IDEAS, ARRANGEMENTS AND PLANS INDICATED BY THESE DRAWINGS ARE THE PROPERTY AND COPYRIGHT OF THE ARCHITECT AND SHALL NEITHER BE USED ON ANY OTHER WORK NOR BE DISCLOSED TO ANY OTHER PERSON FOR ANY USE WHATSOEVER WITHOUT WRITTEN PERMISSION OF THE ARCHITECT.

CLIENT NAME: UNCOMMON DEVELOPERS 9220 N WINNETKA AVE CHATSWORTH, CA 91311

PROJECT NAME: ETHEL

NOT FOR CONSTRUCTION PROJECT ADDRESS:

5511 N ETHEL AVE SHERMAN OAKS, CA

2234 5.31.2023

SHEET TITLE: LEVEL 3

TREES



SHRUBS AND GROUND COVERS



SHRUBS AND GROUND COVERS



SHRUBS AND GROUND COVERS




WESTRINGIA SPECIES
"COAST ROSEMARY"

ARCHITECT JEFF ZBIKOWSKI ARCHITECTURE 4043 IRVING PL, SUITE B CULVER CITY, CA 90232 WWW.JZARCH.LA // 310.853.5004 INFO@JZARCH.LA



Landscape Architecture Site Planning Urban Design

PO Box 704 Montrose CA 91021 Tel 818 797 5914 Web www.tgpinc.net

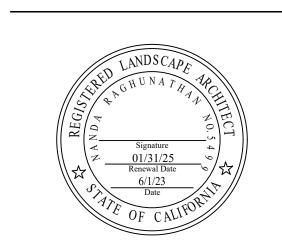

©2022, JEFF ZBIKOWSKI ARCHITECTURE ALL DESIGNS, IDEAS, ARRANGEMENTS AND PLANS INDICATED BY
THESE DRAWINGS ARE THE PROPERTY AND COPYRIGHT OF THE
ARCHITECT AND SHALL NEITHER BE USED ON ANY OTHER WORK NOR
BE DISCLOSED TO ANY OTHER PERSON FOR ANY USE WHATSOEVER
WITHOUT WRITTEN PERMISSION OF THE ARCHITECT.

CLIENT NAME: UNCOMMON DEVELOPERS 9220 N WINNETKA AVE CHATSWORTH, CA 91311

PROJECT NAME:

ETHEL

NOT FOR CONSTRUCTION PROJECT ADDRESS:

5511 N ETHEL AVE SHERMAN OAKS, CA JOB NUMBER:

2234

DATE:
5.31.2023

SHEET TITLE:
PLANT IMAGES